

PRELIMINARY ENGINEERING PLANS **FOR**

AUTO REPAIR FACILITY

3650 N. WILKE ROAD ARLINGTON HEIGHTS, ILLINOIS 60004

PIN NUMBER: 02-01-401-021-0000

OWNER / DEVELOPER

1 OAKBROOK TERRACE, SUITE 600

CONTROL BENCHMARKS:

NATIONAL GEODETIC SURVEY MONUMENT: C0053 1B PID: AJ2849 STAION IS LOCATED AT THE SOUTHEAST CORNER OF THE INTERSECTION OF IL RT

ELEVATION 738.25 (NAVD 88)

NATIONAL GEODETIC SURVEY MONUMENT: LD019 PID: DM3896 STATION IS LOCATED IN THE TOP OF THE EAST CORNER OF THE NORTH END OF A BOX CULVERT FOR BUFFLAO CREEK UNDER LAKE COOK ROAD. ELEVATION 704.99 (NAVD 88)

SITE BENCHMARK:

RIM OF SANITARY STRUCTURE LOCATED EAST OF SITE. ELEVATION 718.97 (NAVD 88)

DUTY TO INDEMNIFY

THE CONTRACTOR SHALL DEFEND, INDEMNIFY, KEEP AND SAVE HARMLESS THE MUNICIPALITY, OWNER, AND ENGINEER, AND THEIR RESPECTIVE BOARD MEMBERS, REPRESENTATIVES, AGENTS AND EMPLOYEES, IN BOTH INDIVIDUAL AND OFFICIAL CAPACITIES, AGAINST ALL SUITS, CLAIMS, DAMAGES, LOSSES AND EXPENSES, INCLUDING ATTORNEY'S FEES, CAUSED BY, GROWING OUT OF, OR INCIDENTAL TO, THE PERFORMANCE OF THE WORK UNDER THE CONTRACT BY THE CONTRACTOR OR ITS SUBCONTRACTORS TO THE FULL EXTENT AS ALLOWED BY THE LAWS OF THE STATE OF ILLINOIS AND NOT BEYOND ANY EXTENT WHICH WOULD RENDER THESE PROVISIONS VOID OR UNENFORCEABLE. THIS OBLIGATION INCLUDES BUT IS NOT LIMITED TO, THE ILLINOIS LAWS REGARDING STRUCTURAL WORK (IL. REV. STAT. CH. 48, PAR.60 AT SEQ.). AND REGARDING THE PROTECTION OF ADJACENT LANDOWNERS (IL. REV. STAT. CH.17 ½ PAR.51 ET. SEQ.). IN THE EVENT OF ANY SUCH INJURY (INCLUDING DEATH) OR LOSS OR DAMAGE, OR CLAIMS THEREFORE, THE CONTRACTOR SHALL GIVE PROMPT NOTICE TO THE OWNER.

NOTES

- 1. SITE ACCESS CONTROL INCLUDING SAFETY FENCES AND TRAFFIC CONTROL, ALL CONSTRUCTION MEANS AND METHODS, AND SITE SAFETY ARE THE SOLE RESPONSIBILITY OF THE CONTRACTOR.
- 2. THE CONTRACTORS SHALL NOTIFY ALL UTILITY COMPANIES FOR FIELD LOCATIONS OF THEIR FACILITIES PRIOR TO BEGINNING CONSTRUCTION. THE CONTRACTOR WILL BE RESPONSIBLE FOR THE MAINTENANCE AND PRESERVATION OF THESE FACILITIES. ALL UTILITIES SHOWN IN THE PLANS ARE FROM RECORDS OR FIELD OBSERVABLE IN FORMATION LOCATED BY SURVEYOR. ANY UTILITY LOCATIONS SHOWN SHALL BE VERIFIED BY THE CONTRACTOR IN THE FIELD.

Sheet List	Table
Sheet Number	Sheet Title
CO	TITLE SHEET
C1	DEMOLITION PLAN
C2	SITE PLAN
С3	GRADING PLAN & DRAINAGE PLAN
T1	TRAFFIC TURNING EXHIBIT
EX-100	EXISTING LANDSCAPE CONDITIONS
LP-100	LANDSCAPE PLAN
LP-500	PLANTING DETAILS

Sheets CO to C3, & T1 were prepared at or under the direction of:



ILLINOIS REGISTERED PROFESSIONAL ENGINEER No. 062-055027 MATTHEW D. WHISLER LICENSE EXPIRES: 11/30/19 SIGNED: 10/10/18

PROJECTED COORDINATE SYSTEM:

NAD_1983_STATEPLANE_ILLINOIS_EAST_FIPS_1201_FEET PROJECTION: TRANSVERSE_MERCATOR

FALSE EASTING: 984250.00000000 FALSE NORTHING: 0.0000000 CENTRAL MERIDIAN: -88.33333333 SCALE FACTOR: 0.99997500 LATITUDE OF ORIGIN: 36.6666667

LINEAR UNIT: FOOT_US

GEOGRAPHIC COORDINATE SYSTEM: GCS_NORTH_AMERICAN_1983

DATUM: D_NORTH_AMERICAN_1983 PRIME MERIDIAN: GREENWICH

ANGULAR UNIT: DEGREE


CALL 48 HOURS BEFORE YOU DIG WITH THE FOLLOWING INFORMATION TOWNSHIP NAME OR NUMBER: 42N, 10E SECTION NUMBER:

Know what's below. Call before you dig.

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18.NPL.C01

OF 5 SHEETS

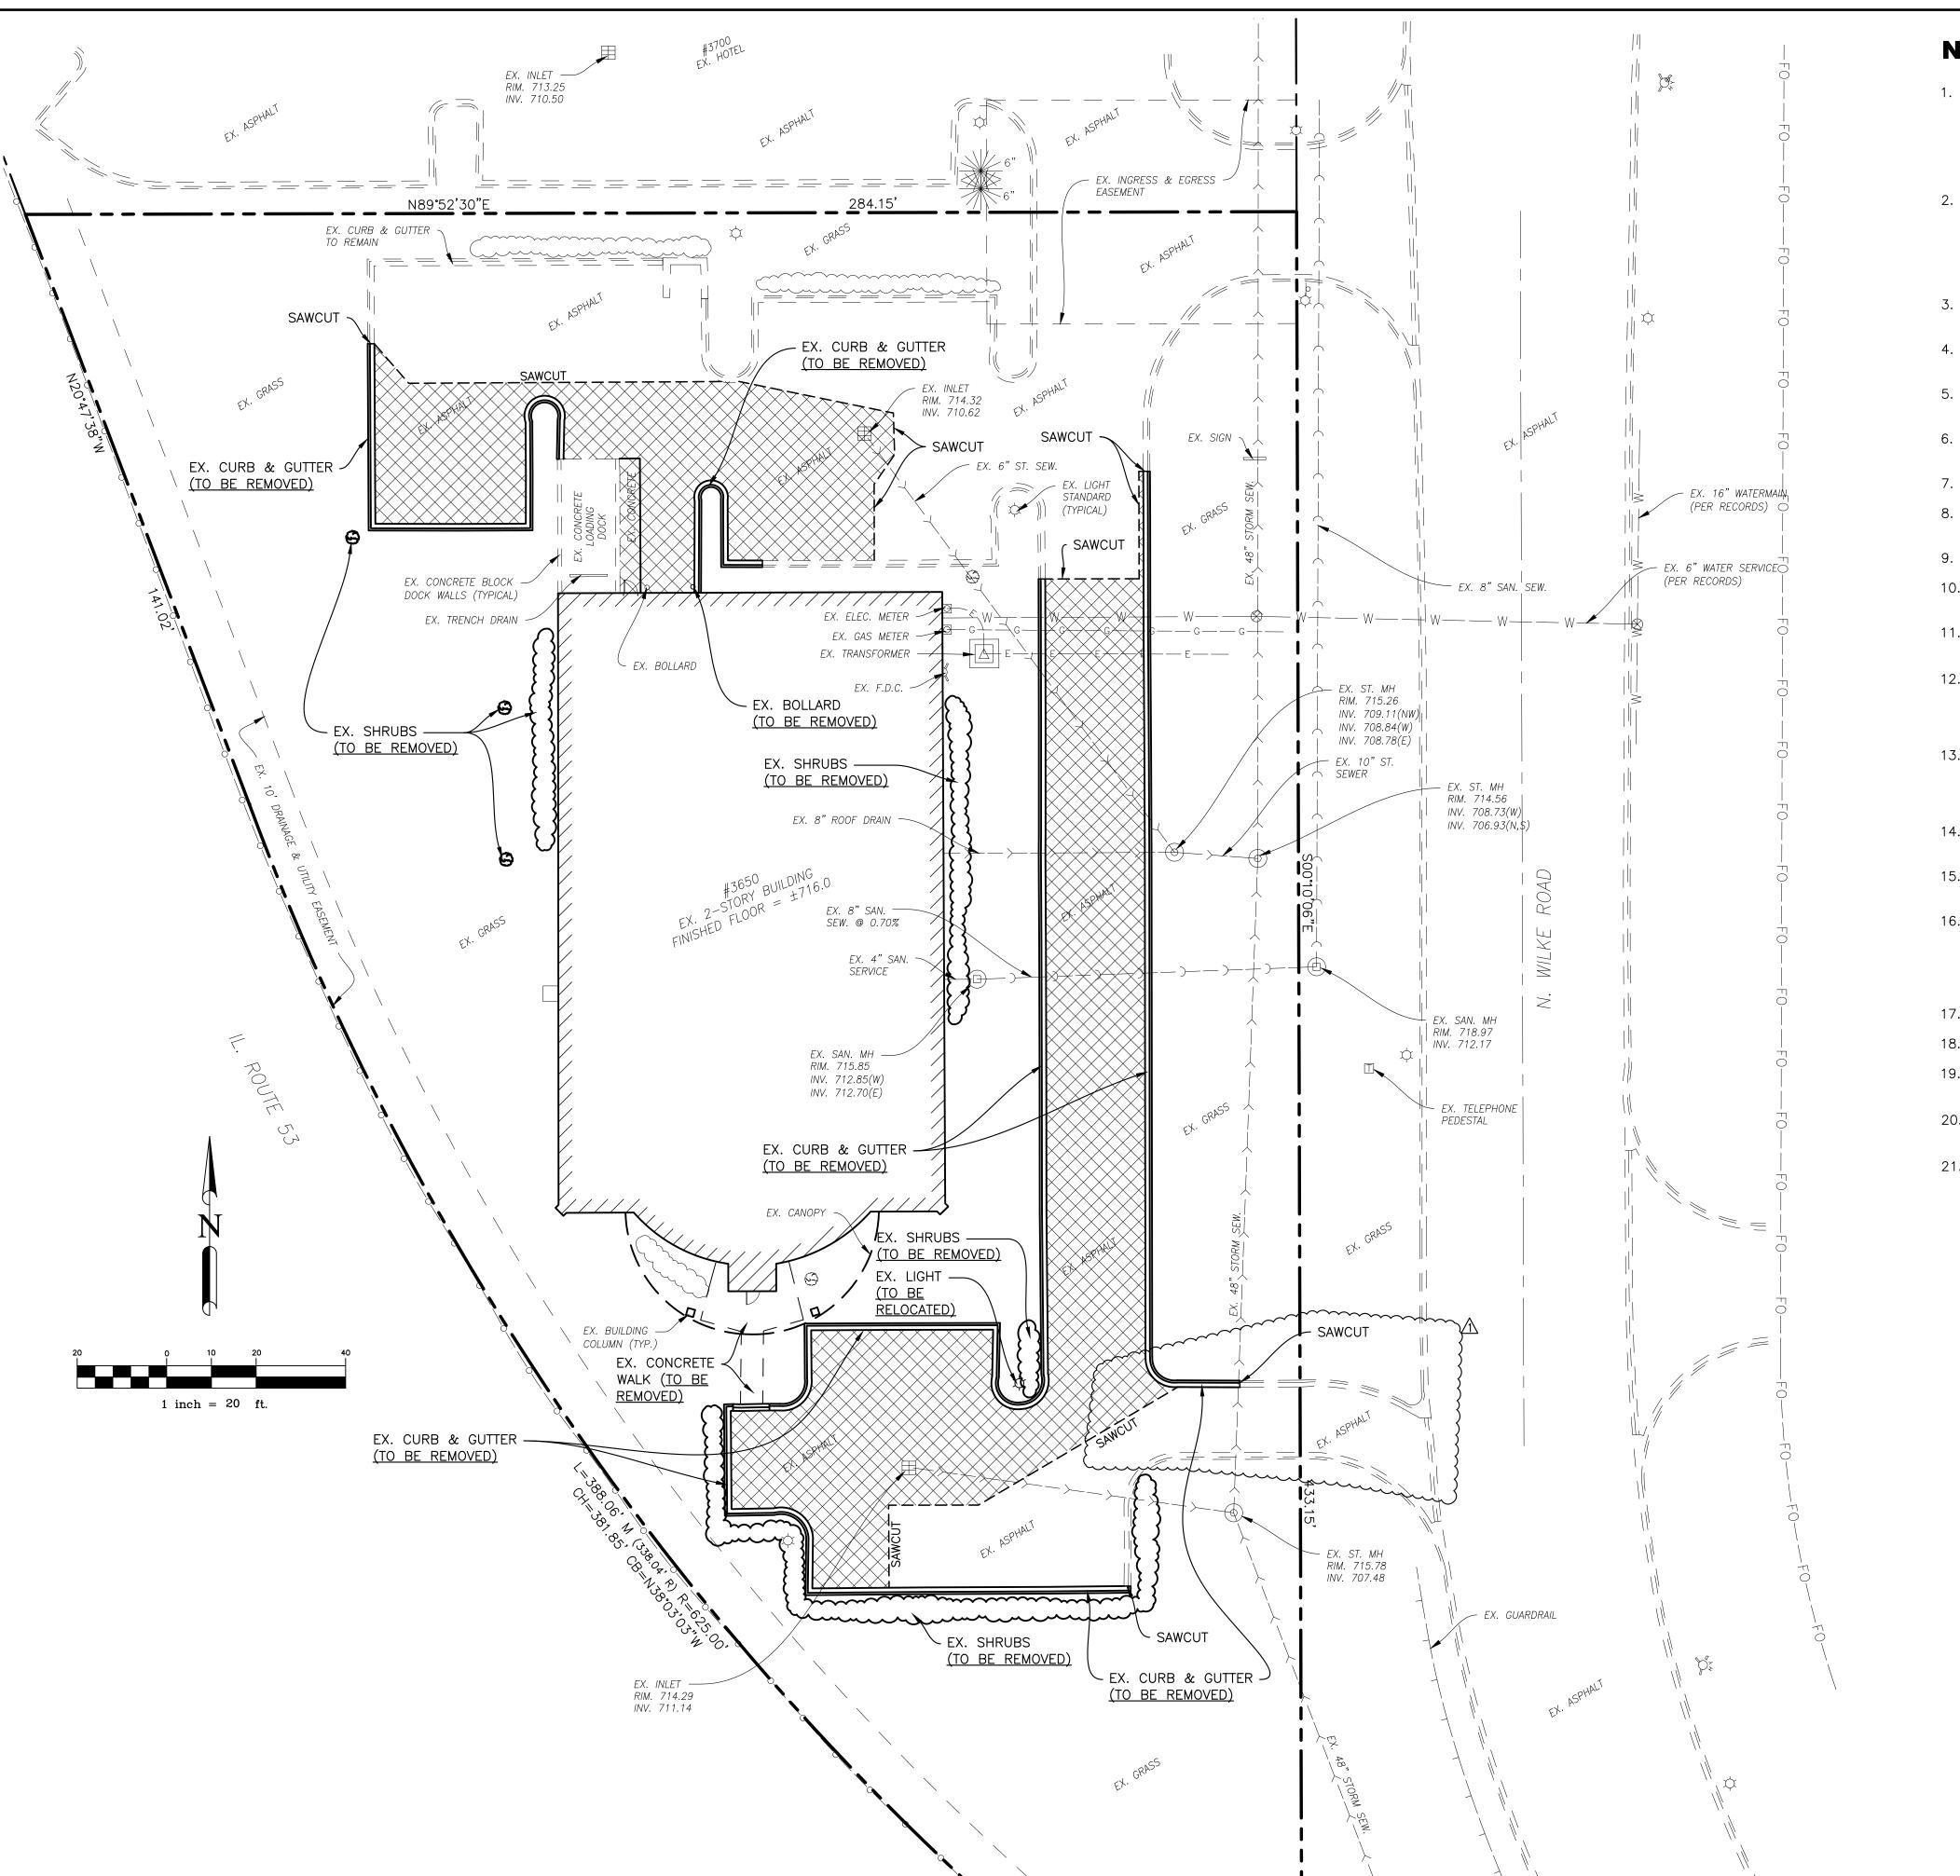

NOTES:


- 1. ALL SITE CLEARING, TOPSOIL STRIPPING, EXCAVATION, EMBANKMENT, GRADING, COMPACTION, SUB GRADE PREPARATION AND OTHER WORK HEREIN CONTEMPLATED SHALL BE CONSTRUCTED IN CONFORMANCE WITH THE APPLICABLE SECTIONS OF THE STANDARD SPECIFICATIONS FOR ROAD AND BRIDGE CONSTRUCTION, ILLINOIS DEPARTMENT OF TRANSPORTATION, JANUARY 2016 EDITION, (HEREINAFTER REFERRED TO AS STANDARD SPECIFICATIONS) EXCEPT THAT PAYMENT WILL BE DEFINED AS DETAILED IN THE STANDARD SPECIFICATIONS FOR WATER AND SEWER SIXTH EDITION, 2009.
- 2. THE EXISTENCE AND LOCATION OF UNDERGROUND UTILITIES SHALL BE INVESTIGATED AND VERIFIED IN THE FIELD BY THE CONTRACTOR BEFORE STARTING WORK IN THE CONSTRUCTION AREA. EXCAVATION IN THE VICINITY OF EXISTING STRUCTURES AND FIBER OPTIC CABLE INSTALLATIONS SHALL BE PERFORMED BY HAND. THE CONTRACTOR SHALL BE HELD RESPONSIBLE FOR ANY AND ALL DAMAGES TO EXISTING FACILITIES, MAINTENANCE AND PROTECTION OF EXISTING UTILITIES AND STRUCTURES AND FIBER OPTIC CABLE INSTALLATIONS.
- 3. THE CONTRACTOR IS TO UNCOVER ALL LINES BEING TIED INTO AND VERIFY GRADES BEFORE ANY CONSTRUCTION.
- 4. CONTRACTOR SHALL BE RESPONSIBLE FOR COORDINATING ALL STREET AND SIDEWALK CLOSURES WITH THE MUNICIPALITY.
- 5. CONDUCT DEMOLITION OPERATIONS AND REMOVAL OF DEBRIS AND SPOILS TO INSURE MINIMAL INTERFERENCE WITH OWNER OPERATIONS.
- 6. INSURE SAFE PASSAGE OF PERSONS AROUND AREAS OF DEMOLITION. REMOVE FROM SITE ALL DEBRIS, RUBBISH AND OTHER MATERIALS RESULTING FORM DEMOLITION AND LAWFULLY DISPOSE OF SAME.
- 7. ALL ITEMS TO BE REMOVED SHALL BE PROPERLY AND LEGALLY DISPOSED OF BY THE CONTRACTOR.
- 8. AT LOCATIONS OF UTILITY REMOVAL, ANY OPEN TRENCHES REQUIRED, SHALL BE BACKFILLED WITH COMPACTED TRENCH BACKFILL.
- 9. NOTIFY UTILITY OWNER 72 HOURS IN ADVANCE OF ANY UTILITY SHUTDOWN.
- 10. THE CONTRACTOR SHALL COORDINATE WITH THE OWNER ALL ITEMS DESIGNATED TO BE REMOVED OR RELOCATED.
- 11. IF ANY ITEMS ARE ENCOUNTERED IN THE FIELD THAT ARE NOT SHOWN ON THE PLAN WHICH REQUIRE DEMOLITION OR RELOCATION, THE CONTRACTOR SHALL NOTIFY THE A/E IMMEDIATELY.
- 12. THE SURVEY BASE PROVIDED HEREIN IS FOR INFORMATIONAL PURPOSES ONLY. THE OWNER, ARCHITECT & ENGINEER(S) ARE NOT RESPONSIBLE FOR ANY MISCHARTED OR UNCHARTED UTILITIES, OR OTHER ERRORS DETECTED. IT IS THE RESPONSIBILITY OF THE CONTRACTOR TO VERIFY ALL SITE CONDITIONS.
- 13. THE CONTRACTOR WILL PROTECT ALL UTILITIES, STREETS, STRUCTURES, VEGETATION, AND ADJACENT PROPERTY DESIGNATED TO REMAIN. ANY DAMAGE BY THE CONTRACTOR TO UTILITIES, STREETS, STRUCTURES, VEGETATION AND ADJACENT PROPERTY WILL BE REPLACED OR REPAIRED AT THE
- CONTRACTOR'S EXPENSE.

 14. CONTRACTOR TO ADJUST RIMS OF EXISTING STRUCTURES WITHIN SCOPE OF WORK TO FINAL GRADE
- 15. EXISTING LATERAL CONNECTIONS FOR UTILITIES SHALL BE COORDINATED WITH THE CORRESPONDING UTILITY COMPANY FOR CAPPING AND CUT OFF WITHIN THE SCOPE OF WORK.
- 16. THE CONTRACTOR IS TO COMPLY WITH FEDERAL, STATE, AND LOCAL ORDINANCES WITH REGARD TO REMOVAL AND DISPOSAL OF MATERIALS FOR ALL ITEMS TO BE DEMOLISHED. WORK INCLUDES THE COMPLETE REMOVAL AND LEGAL DISPOSAL OF ALL OBJECTS AND MATERIALS (REGARDLESS OF THEIR NATURE) INCLUDING BUT NOT LIMITED TO TREE ROOTS, ORGANIC SOIL, DRUMS, TIRES, WOOD, BROKEN CONCRETE PIECES, AND FENCES ABOVE THE REQUIRED ELEVATION.
- 17. BURNING ON OWNERS PROPERTY IS NOT PERMITTED.

ELEVATIONS.

- 18. SIDEWALK DEMOLITION SAWCUTS SHALL BE AT THE NEAREST EXISTING JOINT.
- 19. FULL DEPTH SAWCUTS ARE REQUIRED FOR PAVEMENT REMOVALS, ADJACENT TO EXISTING PAVEMENT TO
- 20. SAWCUT ALL TREE ROOTS ENCOUNTERED IN LIEU OF USING SHOVELS (HAND SHOVELS OR MECHANICAL).
- 21. ALL CONCRETE SAWCUTTING SHALL BE PERFORMED WITH A WETSAW TO CONTROL DUST.

DEMOLITION LEGEND

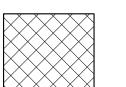

FULL DEPTH PAVEMENT REMOVAL INCLUDING AGGREGATE BASE

DATE DESCRIPTION

8/27/18 PRELIMINARY ENGINEERING

10/10/18 REVISIONS PER VILLAGE

engineering consultants
250, Schaumburg, IL. 60173 T.847.756.4180 www.rln

MOLITION

EXPANSION OF
PLETON ARLINGTON
HEIGHTS CDJR

NAPLE - 13650 N. WIKE - 3650 N. WIKE - 13650 N


SHEET No.

OF 5 SHEETS

NOTES

- 1. TOPOGRAPHIC AND EXISTING CONDITIONS INFORMATION INCLUDING, STRUCTURES, UTILITIES, PROPERTY LIMITS & INFORMATION IS OBTAINED FROM A OWNER PROVIDED SURVEY. RTM ENGINEERING CONSULTANTS, LLC. HAS UTILIZED THIS INFORMATION AND MAKES NO WARRANTY REGARDING THE ACCURACY THEREOF.
- 2. ALL DIMENSIONS ARE MEASURED TO THE FACE OF CURB, UNLESS OTHERWISE NOTED.
- 3. THE CONTRACTOR SHALL VERIFY ALL DIMENSIONS AND CONDITIONS AFFECTING THEIR WORK WITH ACTUAL CONDITIONS AT THE JOB SITE. IF THERE ARE ANY DISCREPANCIES FROM WHAT IS SHOWN ON THE CONSTRUCTION PLAN, HE MUST IMMEDIATELY REPORT SAME TO THE A/E BEFORE DOING ANY WORK, OTHERWISE THE CONTRACTOR ASSUMES FULL RESPONSIBILITIES. IN THE EVENT OF DISAGREEMENT BETWEEN THE CONSTRUCTION PLANS, STANDARD SPECIFICATIONS AND/OR SPECIAL DETAIL, THE CONTRACTOR SHALL SECURE WRITTEN INSTRUCTION FROM THE A/E PRIOR TO PROCEEDING WITH ANY PART OF THE WORK AFFECTED BY OMISSIONS OR DISCREPANCIES, FAILING TO SECURE SUCH INSTRUCTION, THE CONTRACTOR WILL BE CONSIDERED TO HAVE PROCEEDED AT HIS OWN RISK AND EXPENSE. IN THE EVENT OF ANY DOUBT OR QUESTION ARISING WITH RESPECT TO THE TRUE MEANING OF THE CONSTRUCTION PLANS OR SPECIFICATIONS, THE DECISION OF THE A/E SHALL BE FINAL AND CONCLUSIVE.
- 4. COORDINATE BUILDING LAYOUT AND CONNECTION POINTS TO EXISTING BUILDING PER ARCHITECTURAL PLANS, SHOWN ON CIVIL FOR REFERENCE ONLY.
- 5. EXISTING LIGHTING TO REMAIN.
- 6. SCORING PATTERN ON CONCRETE SIDEWALKS SHALL MATCH ADJACENT SIDEWALK PATTERN.
- 7. ALL DISTURBED LANDSCAPE AREAS SHALL BE RESTORED PER THE LANDSCAPE PLANS.

PAVED SURFACE LEGEND

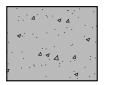

FULL DEPTH CONCRETE PAVEMENT
6" IDOT CLASS PV CONCRETE
4" COMPACTED CA-6 BASE COURSE
(12.5' MAXIMUM JOINT SPACING)



EX. ASPHALT MILL & OVERLAY

1-1/2" COLD-MILLING

1-1/2" HMA SURFACE COURSE, MIX "D", N50, IL9.5




STANDARD DUTY ASPHALT PAVEMENT 1-1/2" HMA SURFACE COURSE 2-1/2" HMA BINDER COURSE IDOT MIX; N50, IL9.5 8" COMPACTED CA-6



CONCRETE SIDEWALK

5" IDOT CLASS SI CONCRETE

4" COMPACTED CA-6

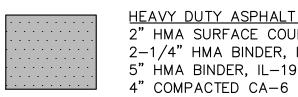

HEAVY DUTY ASPHALT PAVEMENT

2" HMA SURFACE COURSE, MIX "D", N50, IL9.5

2-1/4" HMA BINDER, IL-19.0, N50

5" HMA BINDER, IL-19.0, N30

DIRECTIONAL SIGN LEGEND

1) EXISTING STOP SIGN

ZONING MATRIX

	B-3 DISTRICT CODE REQUIRED	PROPOSED
LOT SIZE	N/A	77,170 SF
LOT WIDTH	N/A	N/A
SETBACKS		
NORTH (REAR)	0'	84.84'
SOUTH (FRONT)	0'	23.11'
EAST (SIDE)	0'	78.51'
WEST (SIDE)	0'	23.11'
FIRST FLOOR AREA	NONE	12,416 SF
MEZZANINE AREA	NONE	3,360 SF
GROSS FLOOR AREA	NONE	15,776
F.A.R.	350%	20.4% (15,776/77,170)
BUILDING LOT COVERAGE	NONE	12,416 SF
IMPERVIOUS SURFACE COVERAGE	NONE	43,462 SF
BUILDING HEIGHT	NONE	±25'-10"
OFF-STREET PARKING SPACES		72 SPACES

DATE DESCRIPTION No. DATE DESCRIPTION
8/27/18 PRELIMINARY ENGINEERING
0/10/18 REVISIONS PER VILLAGE

engineering consultants

SITE PLA

APLETON ARLINGTON HEIGHTS CDJR

PROJECT No.

18.NPL.CO1

SHEET No.



- 1. PROPOSED ELEVATIONS SHOWN ON PROPOSED CURB LINES ARE FLOW LINE ELEVATIONS/TOP OF PAVEMENT, UNLESS NOTED OTHERWISE. ADD 0.50' TO OBTAIN TOP OF CURB ELEVATIONS.
- 2. A CONSTANT SLOPE SHALL BE MAINTAINED BETWEEN SPOT GRADES.
- 3. RIM GRADES ALONG CURBS ARE FLOW LINE ELEVATIONS.
- 4. ALL GRADING, BACKFILLING, COMPACTION, EXCAVATION, ETC., SHALL BE IN ACCORDANCE WITH THE RECOMMENDATIONS SET FORTH IN THE GEOTECHNICAL INVESTIGATION REPORT. REFER TO THE REPORT FOR ADDITIONAL INFORMATION NOT TRANSFERRED TO THESE PLANS.
- 5. CONTRACTOR SHALL FIELD VERIFY ALL EXISTING SPOT ELEVATIONS PRIOR TO ANY CONSTRUCTION AND REPORT ANY DISCREPANCIES TO THE ENGINEER IMMEDIATELY.
- 6. OWNER'S REPRESENTATIVE TO VERIFY THAT BUILDING FOUNDATION AND PAVED ARE SUBGRADE SOILS ARE SUITABLE AND COMPACTED PER GEOTECHNICAL REPORT.
- 7. BOUNDARY AND TOPOGRAPHIC SURVEY PREPARED BY INTECH CONSULTANTS DATED JULY 24, 2018.

GRADING PLAN LEGEND

RIDGE LINE	
TOP OF CURB	TC:XX.XX
TOP OF WALK	W:XX.XX
TOP OF PAVEMENT	P:XX.XX
TOP OF DEPRESSED CURB	D:XX.XX
FLOW LINE	F:XX.XX
EDGE OF PAVEMENT	EP:XX.XX
FINISHED GRADE	G:XX.XX
MATCH EXISTING	ME:XX.XX

STORMWATER SUMMARY

VILLAGE OF ARLINGTON HEIGHTS: TOTAL SITE = 77,170 S.F.

EXISTING PERVIOUS AREA = 42,854 S.F. = 0.984 AC.

EXISTING IMPERVIOUS AREA = 34,316 S.F. = 0.788 AC. WEIGHTED "C" FACTOR = 0.70 STORAGE REQUIRED PER VAH SPREADSHEET = 0.46 AC.FT.

PROPOSED PERVIOUS AREA = 33,808 S.F. = 0.776 AC. PROPOSED IMPERVIOUS AREA = 43,362 S.F. = 0.995 AC WEIGHTED "C" FACTOR = 0.75

STORAGE REQUIRED PER VAH SPREADSHEET = 0.470 AC.FT.

DIFFERENCE STORAGE REQUIRED TO BE PROVIDED = 0.044 AC.FT. = 1,901 CU.FT.

STORAGE PROVIDED IN PROPOSED BASIN = 0.045 AC.FT.

= 1,944 CU.FT.

VILLAGE OF ARLINGTON HEIGHTS ALLOWABLE RELEASE RATE = 0.18 CFS/ACRE SITE AREA = 0.788 ACRES

ALLOWABLE RELEASE RATE = 0.32 CFS
PROVIDE 2.5" DIAMETER PLATE RESTRICTOR AT ELEV. 711.74
ACTUAL RELEASE RATE AT HWL 715.00 = 0.30 CFS (OKAY)

MWRD VOLUME CONTROL SUMMARY:

MWRD VOLUME CONTROL SUMMARY: TOTAL AREA = 34,639F. = 0.80

IMPERVIOUS AREA = 21,107 S.F. = 0.48 AC.

VOLUME CONTROL REQUIRED = $21,107 * \frac{1}{12} = 1,758$ CU.FT.

VOLUME STORAGE PROVIDED = 1,944 CU.FT.

No. DATE DESCRIPTION

1 8/27/18 PRELIMINARY ENGINEERING

1 10/10/18 REVISIONS PER VILLAGE




GRADING & DRAINAGE PLA

JECT: EXPANSION OF VAPLETON ARLINGTON HEIGHTS CDJR


PROJECT No.

18.NPL.CO1

SHEET No.

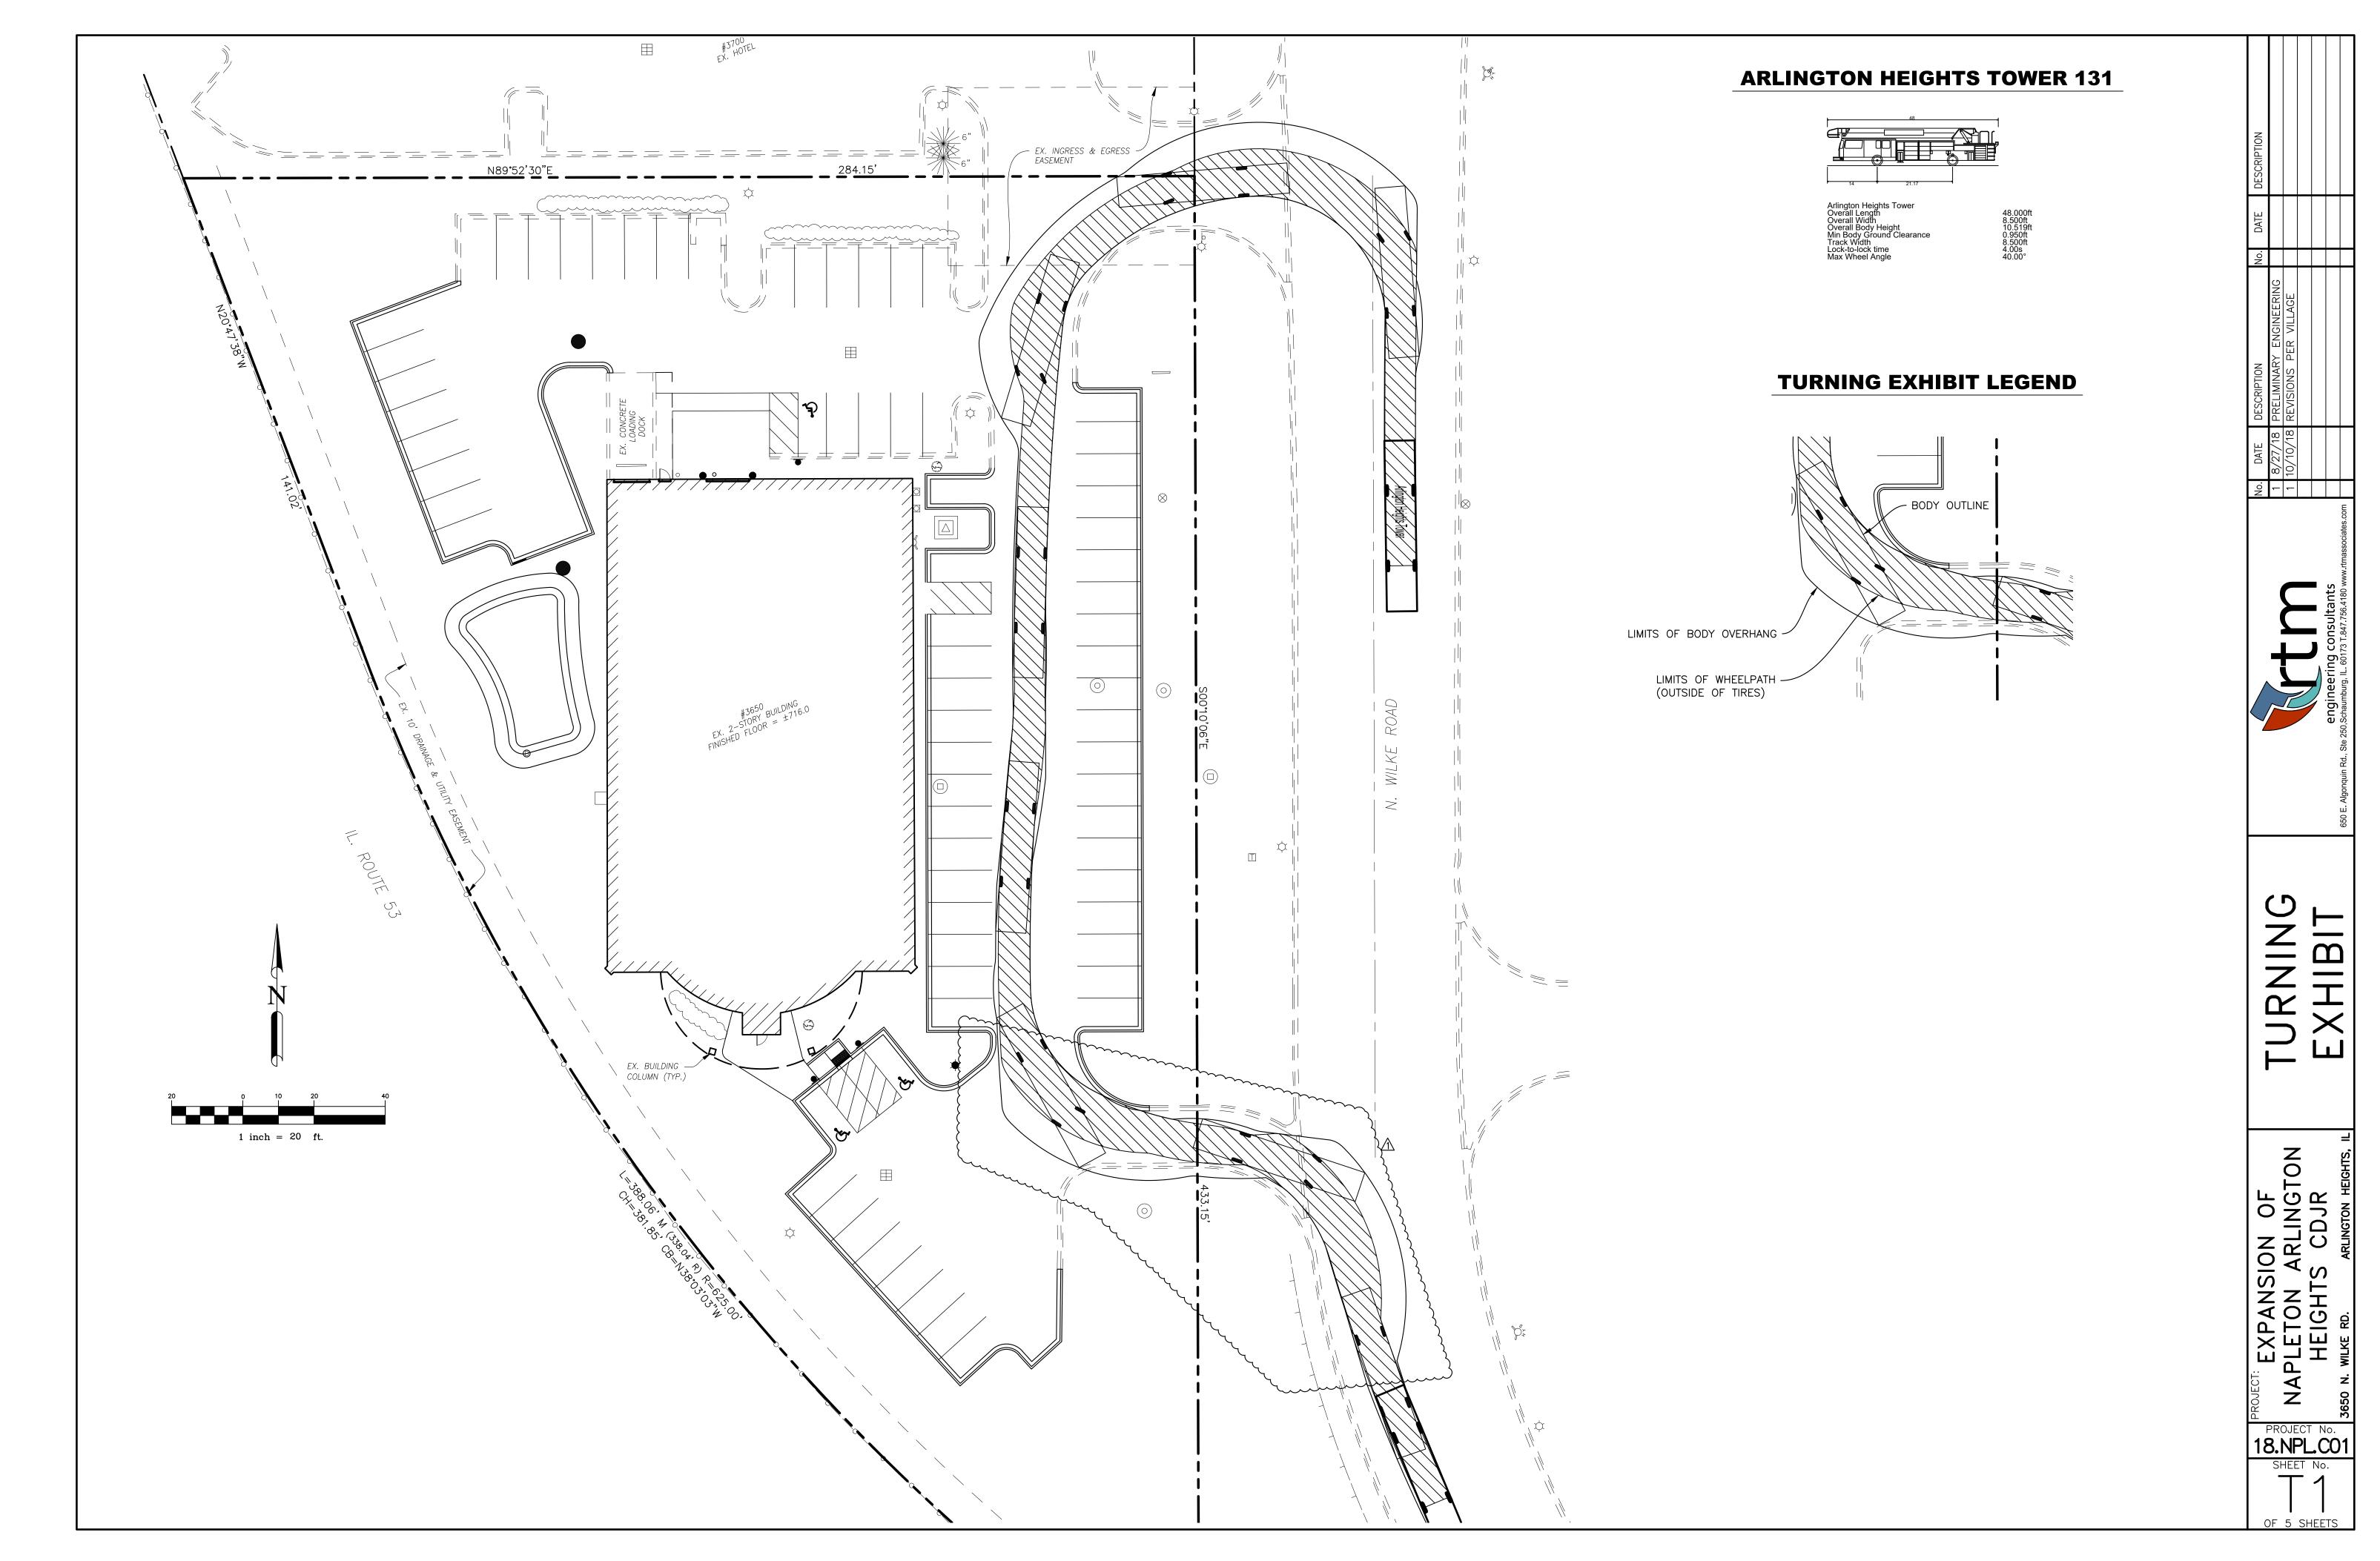

er: matt.whisler File: J:\2018\18.NPL.C01 Arlington Heights CDJR\02—DWG\01—Preliminary\02—Sheets\T1 TURNING EXHIBIT.dwg Time: Oct 10, 2018 — 1

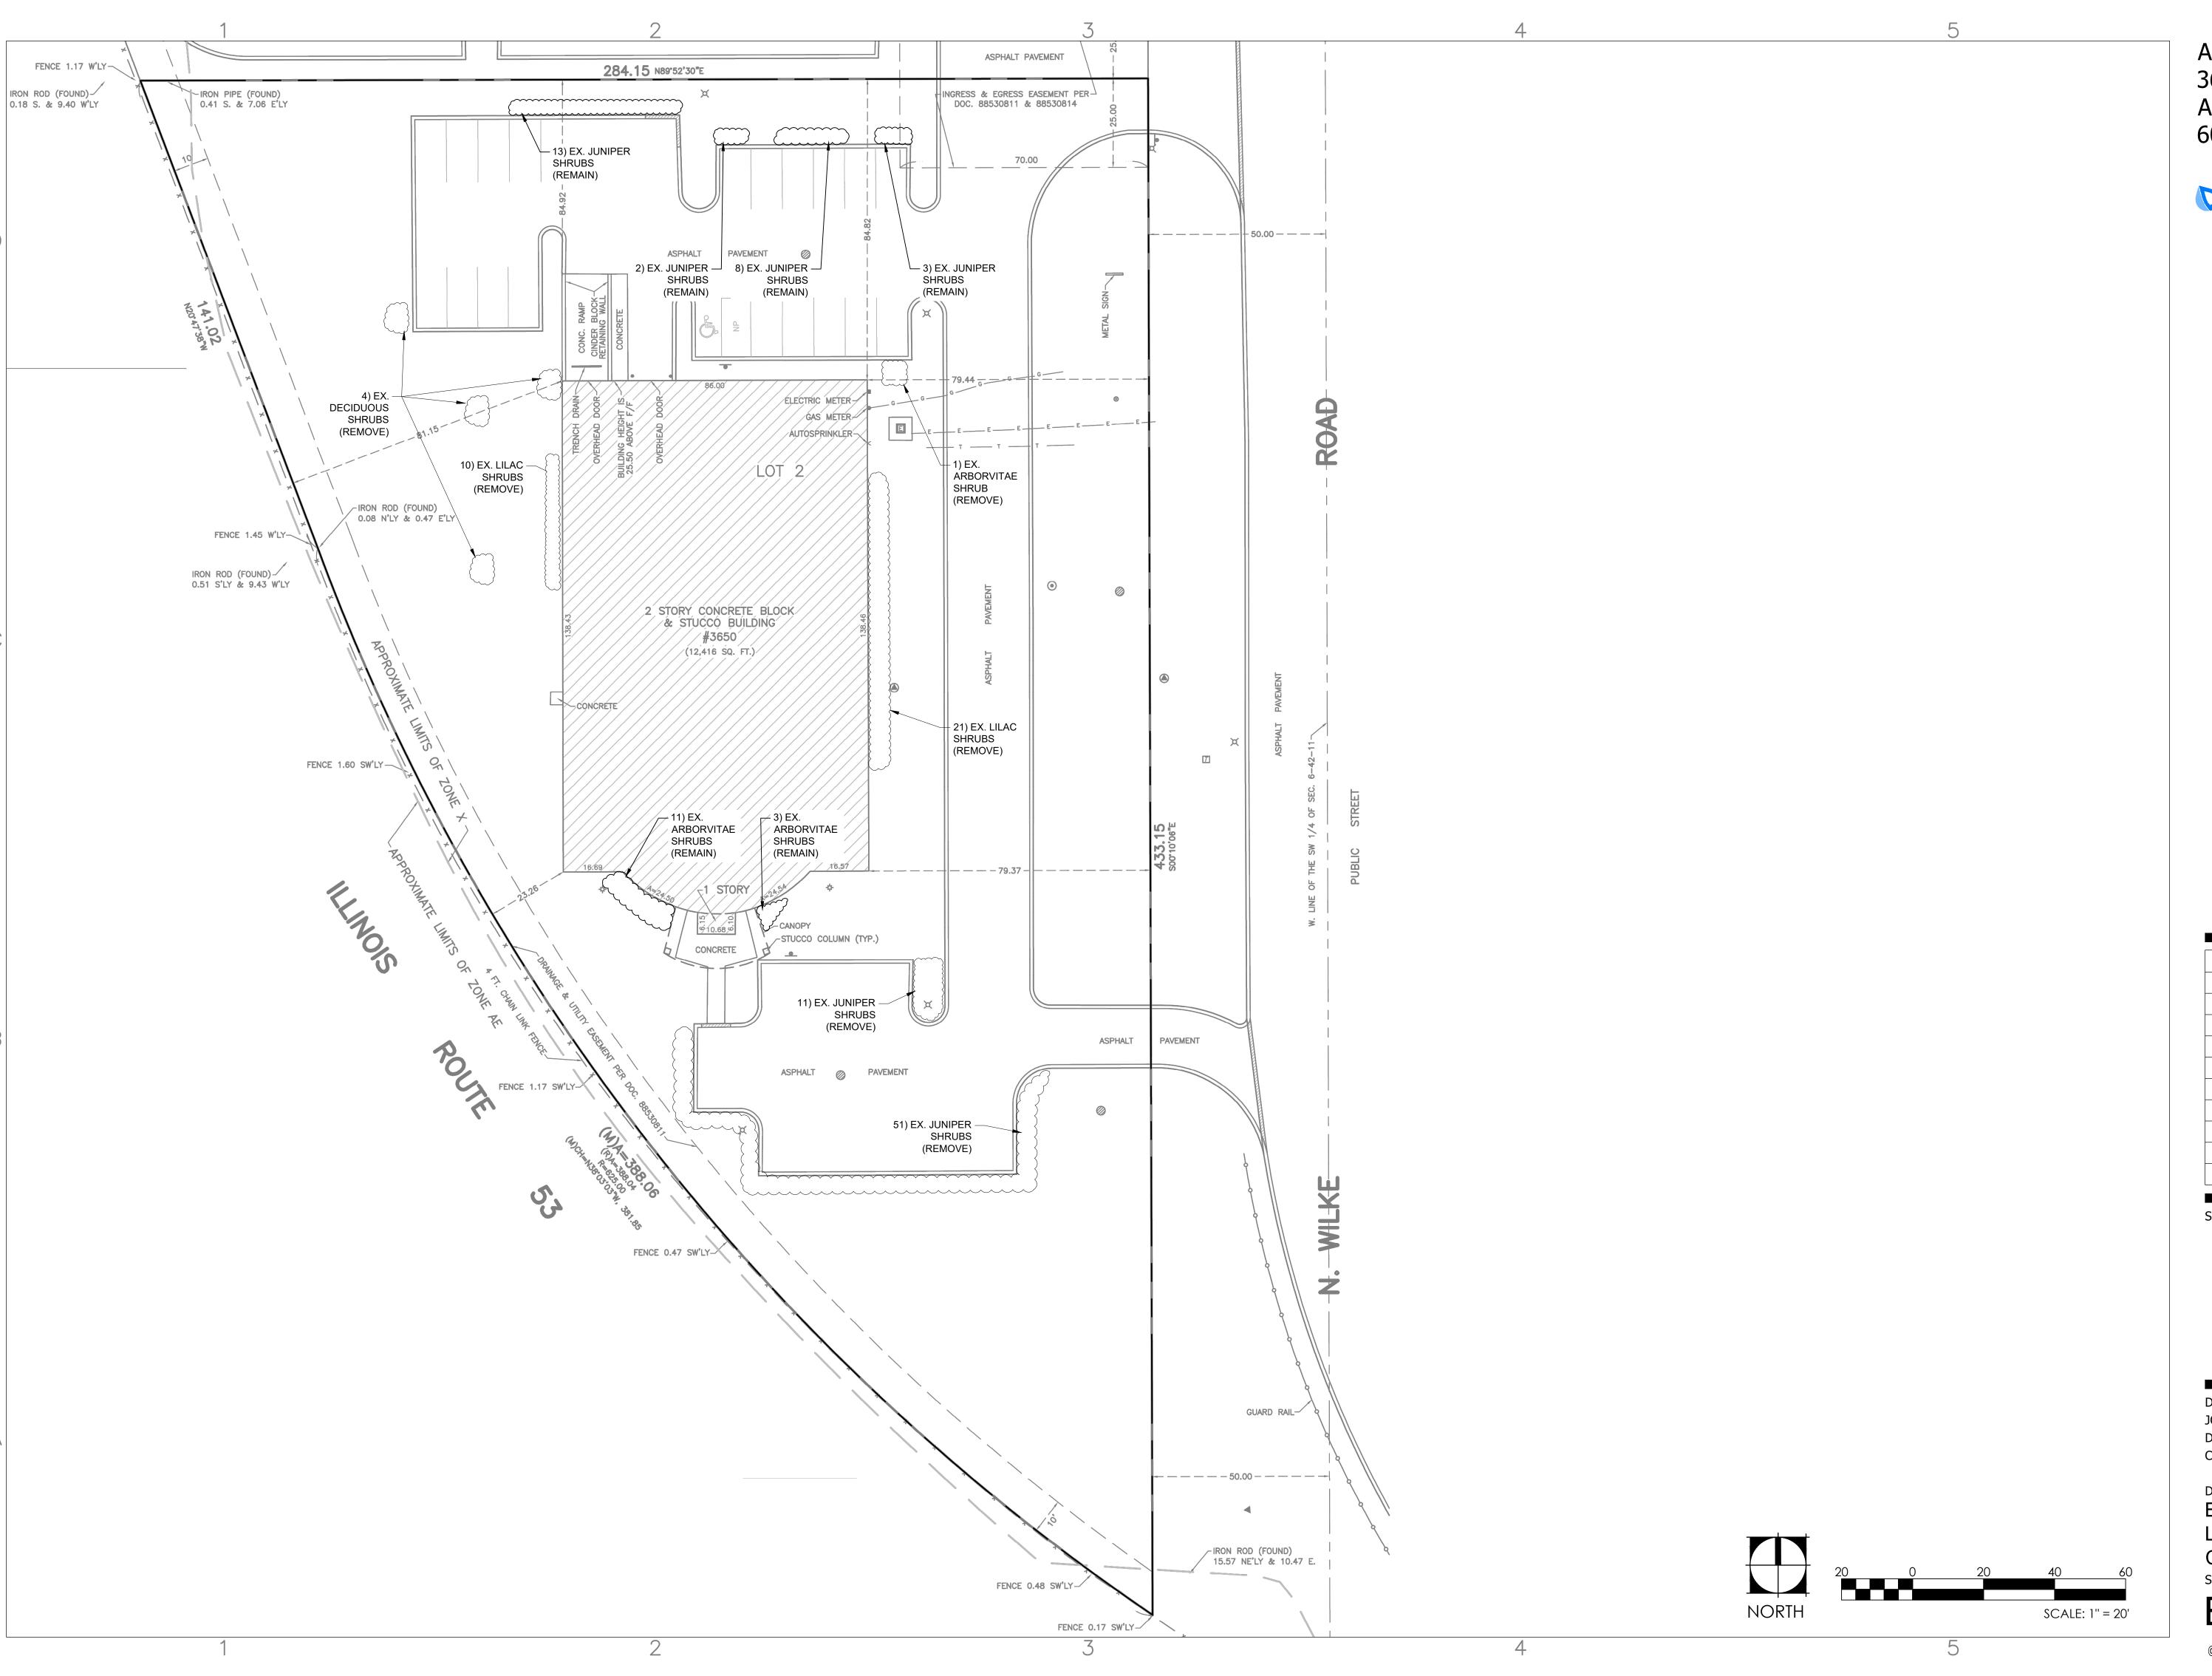

Auto Repair Facility 3650 N. Wilke Road Arlington Heights, IL 60004



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REV.	COMMENT	DATE
1	ZONING APPLICATION APPROVAL	8/24/18

SEAL




DATE:6/13/2018 JOB NO.:18-8004 DRAWN BY:CE CHECKED BY:TS

DRAWING TITLE:
EXISTING
LANDSCAPE
CONDITIONS
SHEET NO.:

EX-100

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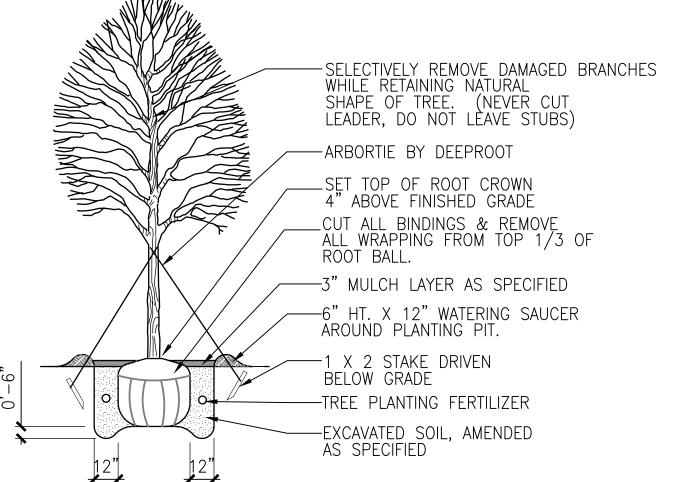


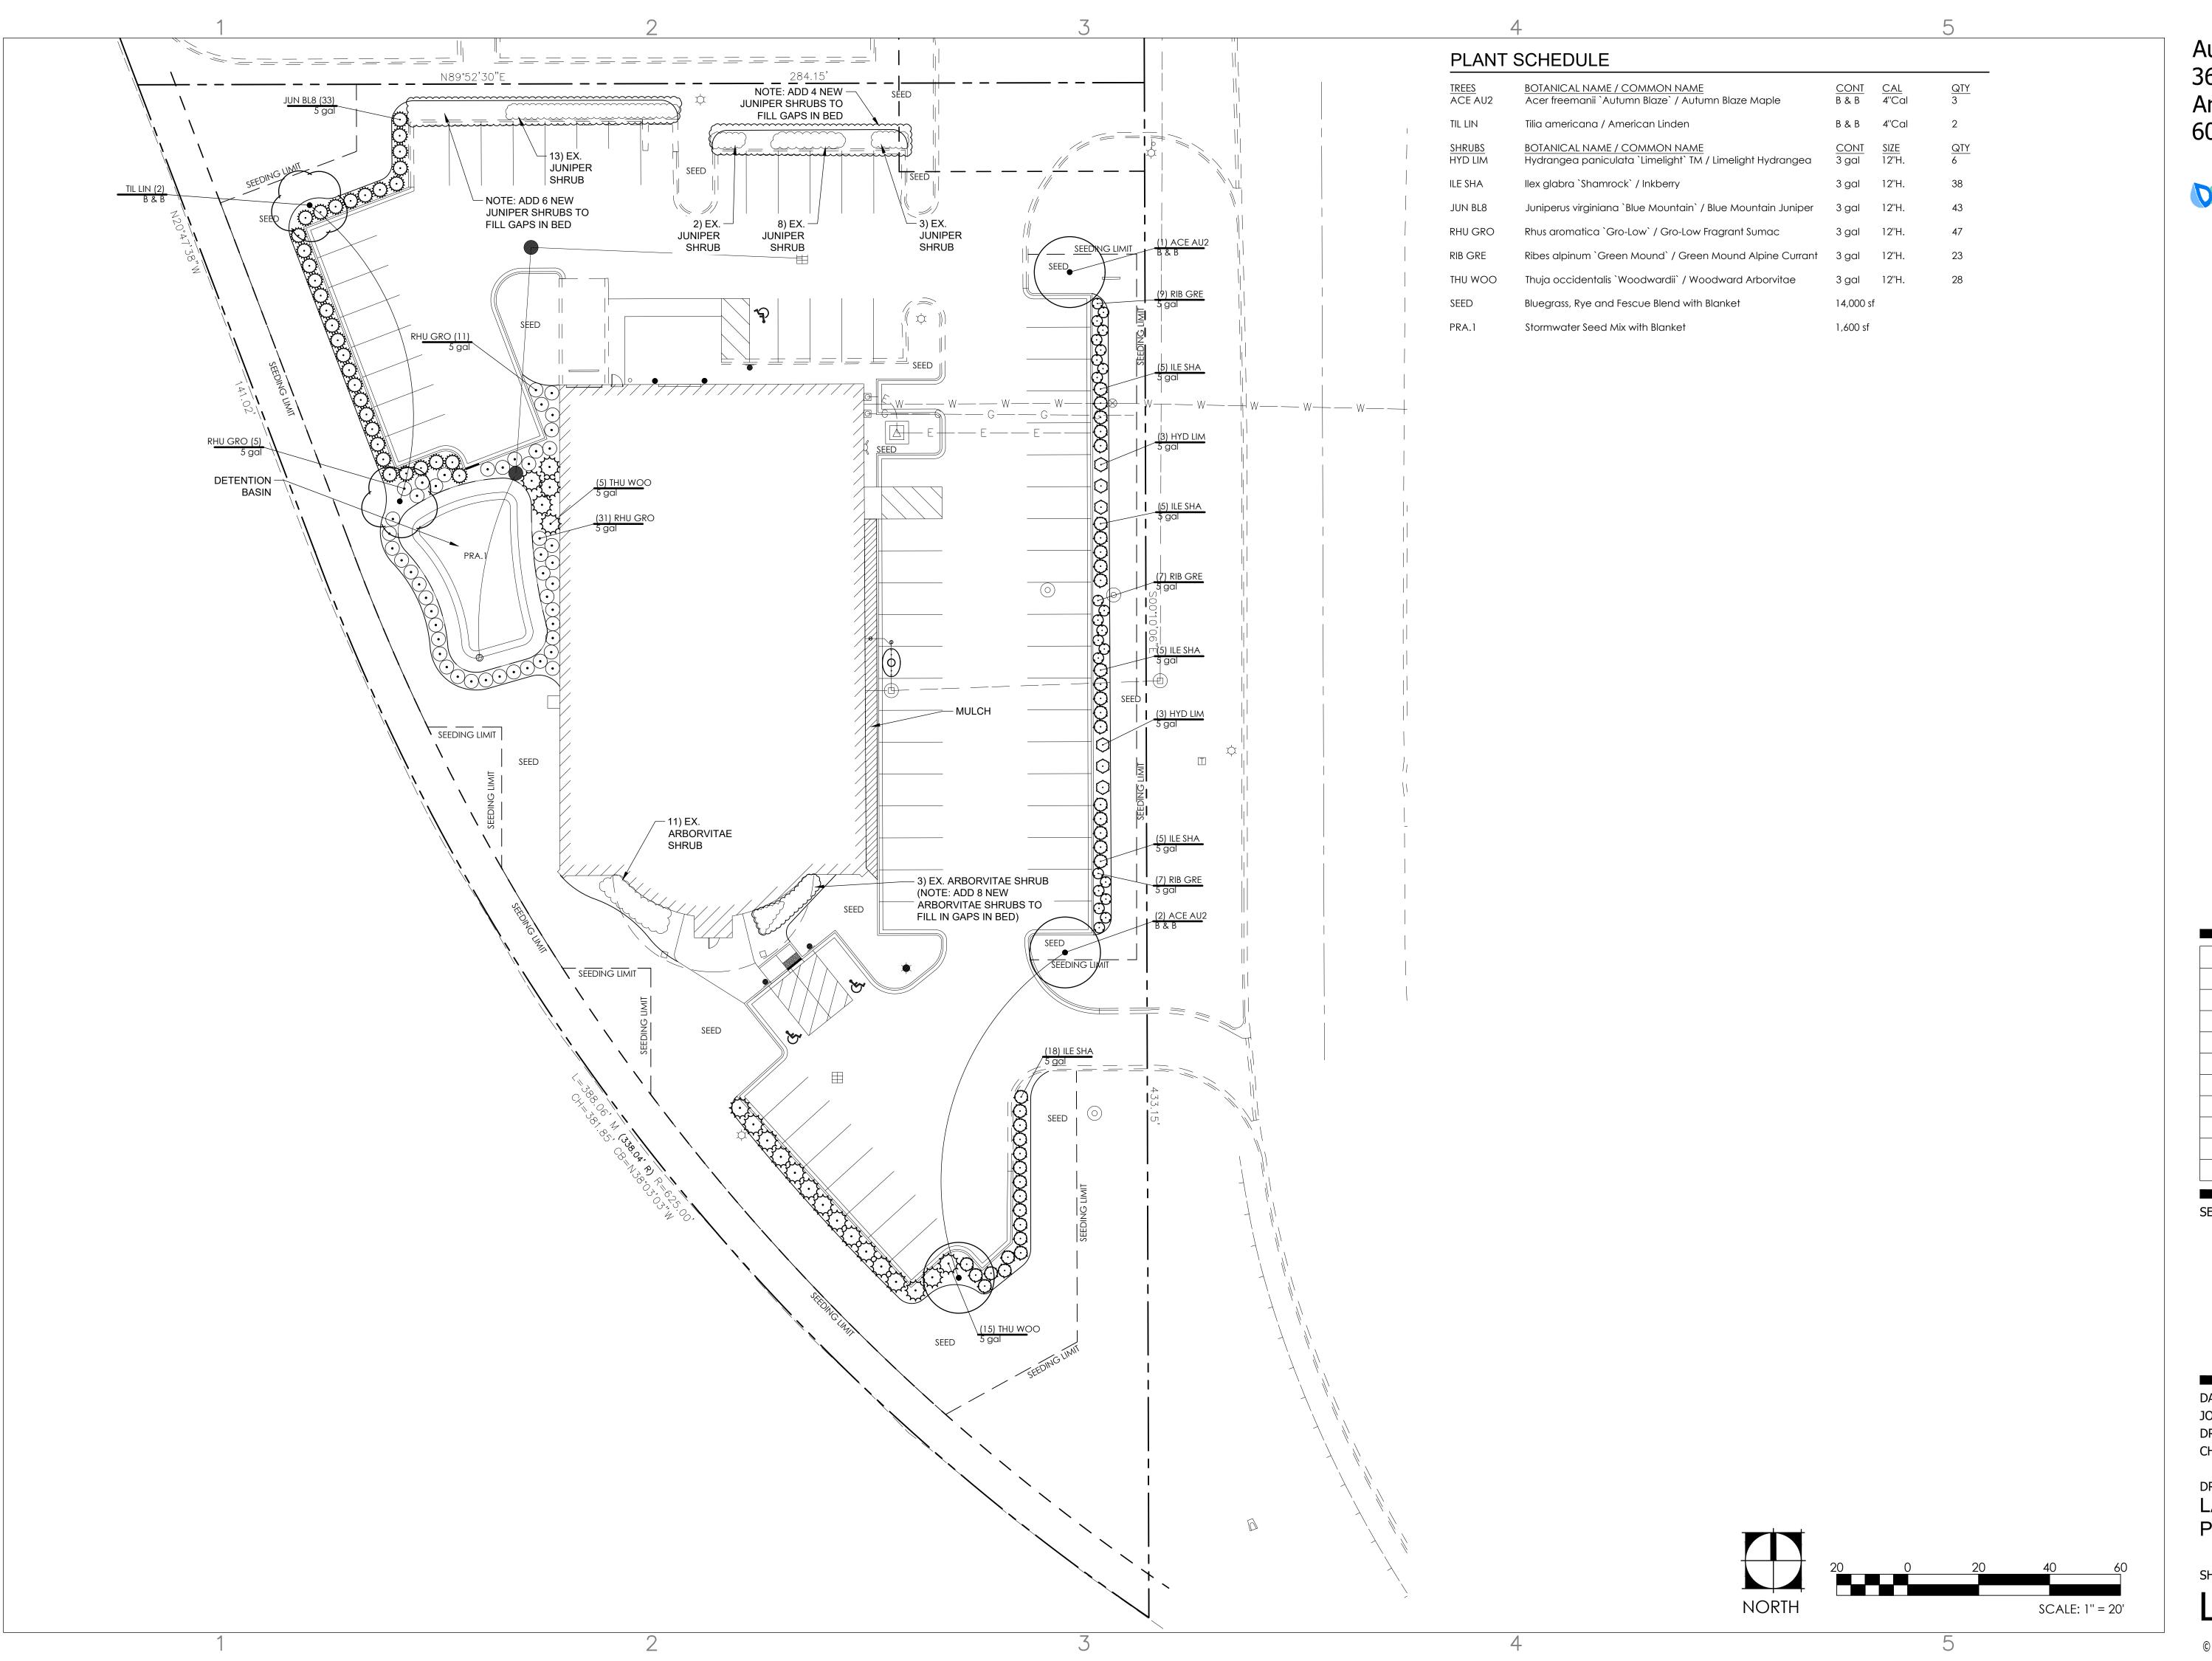DATE:6/13/2018 JOB NO.:18-8004 DRAWN BY:CE CHECKED BY:TS

DRAWING TITLE: LANDSCAPE PLAN

SHEET NO.:


LP-100



SHADE TREE PLANTING

SCALE: 1/4"=1'-0"


DT-tree-w-wire-gyn

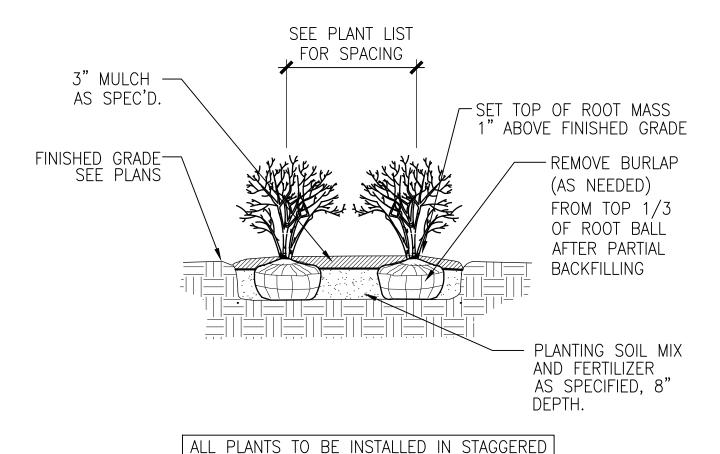

ROWS UNLESS OTHERWISE NOTED ON PLANS

SHRUB PLANTING DETAIL

_____ DT—shrub—gyn

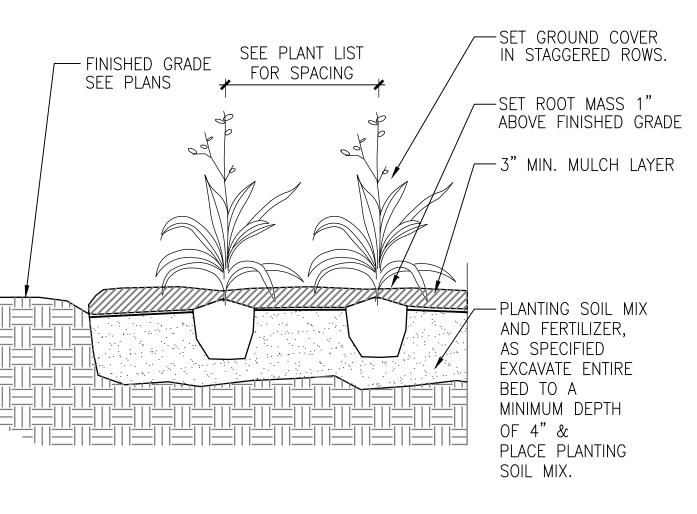

GROUNDCOVER PLANTING

SCALE: 1"-1'-0"

DT-groundcover-gyn

- 1. THE LANDSCAPE CONTRACTOR SHALL BE REPSONSIBLE FOR MAKING HIMSELF FAMILIAR WITH ALL UNDERGROUND UTILITIES AND STRUCTURES. SEE CONSTRUCTION NOTES.
- 2. DO NOT WILLFULLY PROCEED WITH PLANTINGS AS DESIGNED WHEN IT IS OBVIOUS THAT OBSTRUCTIONS AND/OR GRADE DIFFERENCES EXIST THAT MAY NOT HAVE BEEN KNOWN DURING THE DESIGN PROCESS. SUCH CONDITIONS SHALL BE IMMEDIATELY BROUGHT TO THE ATTENTION OF THE PROJECT MANAGER. THE LANDSCAPE CONTRACTOR WILL BE HELD RESPONSIBLE FOR ANY NECESSARY REVISIONS AND COSTS DUE TO FAILURE TO GIVE SUCH NOTIFICATION.
- 3. THE LANDSCAPE CONTRACTOR SHALL BE RESPONSIBLE FOR ANY COORDINATION WITH SUBCONTRACTORS AND/OR SUPPLIERS AS REQUIRED TO ACCOMPLISH PLANTING OPERATIONS.
- 4. THE LANDSCAPE CONTRACTOR IS TO RECEIVE THE SITE AT $\pm 1/10$ TH OF AN INCH.
- 5. REFER TO SPECIFICATIONS FOR PLANTING REQUIREMENTS, MATERIALS, AND EXECUTION.
- 6. ALL TREES SHALL BE TAGGED BY THE PROJECT MANAGER AT A NURSERY SELECTED BY THE LANDSCAPE CONTRACTOR OR AT THE DISCRETION OF THE PROJECT MANAGER.
- 7. FINAL LOCATION OF ALL PLANT MATERIAL SHALL BE SUBJECT TO APPROVAL OF THE PROJECT MANAGER PRIOR TO DIGGING ANY HOLES. THE LANDSCAPE CONTRACTOR IS RESPONSIBLE FOR PROVIDING PROJECT MANAGER ADEQUATE ADVANCE NOTICE FOR ON—SITE APPROVALS. THE LANDSCAPE CONTRACTOR IS TO THE FOLLOWING BEFORE BEGINNING INSTALLING PLANTINGS:
- SHRUBS LAY OUT THE ACTUAL CONTAINERS ON-SITE BEFORE DIGGING HOLES.
- TREES STAKE THE LOCATIONS BEFORE DIGGING HOLES. ANY TREE PLANTED WITHOUT ITS FINAL LOCATION APPROVED BY THE PROJECT MANAGER MAY BE REQUESTED TO BE RELOCATED AT THE SOLE EXPENSE OF THE LANDSCAPE CONTRACTOR.
- 8. THE LANDSCAPE CONTRACTOR SHALL NOTIFY THE PROJECT MANAGER AT LEAST 48 HOURS IN ADVANCE PRIOR TO COMMENCEMENT OF WORK TO COORDINATE PROJECT OBSERVATION SCHEDULES.
- 9. IF CONFLICTS ARISE BETWEEN THE ACTUAL SIZE OF AREAS ON THE SITE AND THE DRAWINGS, CONTACT THE PROJECT MANAGER FOR RESOLUTION.
- 10. IT IS THE LANDSCAPE CONTRACTOR'S RESPONSIBILITY TO FURNISH PLANTS FREE OF PESTS AND/OR DISEASES. PRE—SELECTED OR "PROJECT MANAGER TAGGED" PLANT MATERIAL MUST BE INSPECTED BY THE LANDSCAPE CONTRACTOR AND CERTIFIED PEST AND DISEASE FREE. IT IS THE LANDSCAPE CONTRACTOR'S OBLIGATION TO WARRANTY ALL PLANT MATERIAL PER THE SPECIFICATIONS.
- 11. GROUNDCOVERS AND SHRUBS ARE TO BE TRIANGULARLY SPACED UNLESS INDICATED ON THE PLANS.
- 12. ALL TREES WITHIN A SPECIES SHALL HAVE MATCHING FORM, UNLESS OTHERWISE NOTED.
- 13. ALL TREES, SHRUB AND GROUNDCOVER AREAS (EXCLUDING TURF AND SLOPE AREAS) ARE TO BE MULCHED PER DETAILS.
- 14. ALL MULCH TO BE PREMIUM SHREDDED HARDWOOD MULCH, NATURAL BROWN COLOR.
- 15. TREES SHALL BE SET BACK A MINIMUM OF TEN FEET (10') HORIZONTALLY FROM UTILITY STRUCTURES, INCLUDING, BUT NOT LIMITED TO, MANHOLES, VALVE VAULTS, VALVE BOXES, FIRE HYDRANTS, TRANSFORMERS AND SWITCH CANS. TREES SHALL BE SET BACK A MINIMUM OF FIVE (5') HORIZONTALLY FROM SANITARY SEWER AND WATER SERVICES. CONTRACTOR TO MAKE NECESSARY ADJUSTMENTS UNDER THE APPROVAL OF OWNER. REFER TO CIVIL DRAWINGS PREPARED BY OTHERS.
- 16. PLANTING RESTRICTIONS: PLANT DURING ONE OF THE FOLLOWING PERIORDS. COORDINATE PLANTING PERIODS WITH MAINTENANCE PERIODS TO PROVIDE REQUIRED MAINTENANCE FROM DATE OF SUBSTANTIAL COMPLETION.
 - 1. SPRING PLANTING: 4/1 6/15 2. FALL PLANTING: 9/1 - 11/1



DT-plantnote-gyn

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SEAL:



DATE:6/13/2018 JOB NO.:18-8004 DRAWN BY:CE CHECKED BY:TS

DRAWING TITLE:
PLANTING
DETAILS

SHEET NO.:

LP-500

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