

Petitioner: AMAZON TRANSPORTATION ENGINEERING SERVICES

Contact: ASHER COUSIN / ROBERT GREEN, AIA

Date: MAY 1, 2020

Project: DLN3 – DELIVERY STATION Location: 1455 W. SHURE DRIVE

SIGN VARIATION APPLICATION - JUSTIFICATION

The proposed signage for the subject project exceeds the requirements of Chapter 30 Sign Code of the Village of Arlington Heights.

Variations sought:

- 1. Permission to install more than one wall sign. The primary wall sign is on the west elevation towards Cellular Drive. A secondary sign ("Amazon Hub") is requested at the south end of the west wall which is important to direct customers to the customer service location and to acknowledge the services provided there ("customer service/package pickup & return"). A fourth sign identifies "associate entry" on the south building elevation.
- 2. Permission to have more than one ground sign and to exceed permitted signage sizes. The existing ground sign will remain and be modified to bear the new tenant identification. Additional signs are required for direction of employee, visitor and delivery departure and arrival traffic flow.
- <u>a. Particular Difficulty</u>: The site, floor plan and existing building construction orients all vehicular traffic off of Cellular Drive to the north. Vehicular traffic types include customers, office employees, delivery vans and tractor-trailer delivery trucks. Site signage is designed intending to organize vehicle traffic types and sign sizes are based on vehicle movement (speed, direction and interaction with other traffic). With the truck court and utilities dominating the northern building area, the office area is located at the southern end of the building. Consequently, customer traffic for the *Amazon Hub* a critical business offering which includes customer service, package pick up and drop off must be directed by signage from the street entry drive to the appropriate building area, located at the far (south) end of the building. The customer service center requires signage branding, based on the Amazon Worldwide design standards. Additionally, the employee entrance on the south building elevation requires signage which also conforms to these design standards.
- <u>b. No Detrimental Impact</u>: All building and ground signage is professionally manufactured following Amazon Worldwide design standards. The customer service and associates entry enhancements and related signage are frequently regarded as betterment to the property. The directional and traffic signs are important to organize and queue the varied drivers for safety and clarity to guide them to the correct destination on the property. All signs are limited to the minimum to avoid excess, while providing for safe travel on the site and do not create a traffic hazard or a depreciation of nearby property values or cause otherwise detrimental effect.

Sign Variance Application – Justification

1455 W. SHURE DRIVE May 1, 2020

Page 2 of 2

<u>c. Hardship Relief</u>: This variation will relieve the applicant from difficulty attributable to the existing site constraints and building construction and will provide important traffic direction for varied vehicle types and driver queues as well as enabling customers to access a significant business function in the appropriate location within the building layout.

<u>d. Not Alter Essential Character of Locality</u>: It is believed that the signage requesting variation are consistent with the character of the property and local environment. All are consistent with the character and nature of, and are respectful to, neighboring businesses.

e. Standards Limitations on Business: Disallowance of the requested variation will result in vehicular traffic confusion on Cellular Drive as well as throughout the site. Also, the additional building signs will eliminate confusion in wayfinding for visitors and employees of various types. Proposed signage follows the Amazon Worldwide design standards and alteration of design or general intended placement will deprive the applicant of their ability to properly brand the property as well as the Amazon Hub customer service business element which is provided at each delivery station property.

We hope this information adequately conveys the importance of the requested variance.

RICHARD L. BOWEN + ASSOCIATES INC.

Robert Green, AIA, NCARB Senior Project Manager

cc: Craig Phillips - Griffin Capital Real Estate

Asher Cousin - Amazon

Justin Risetter, Erik Eckberg – Krusinski Constriction



Petitioner: AMAZON TRANSPORTATION ENGINEERING SERVICES

Contact: ASHER COUSIN / ROBERT GREEN, AIA

Date: MAY 1, 2020

Project: DLN3 DELIVERY STATION Location: 1455 W SHURE DRIVE

SIGNAGE MATERIAL LIST

Monument Sign Color: Black Acrylic ½" Cut Letters on White Backing

Resurfacing Existing Monument Sign. Non-illuminated

Building-Mounted Delivery Sign Color: White Acrylic w/ Grey Vinyl Overlay

Product: Acrylic Face LED Internally Illuminated Signage

Building-Mounted Hub Sign Color: White Acrylic w/ Grey Vinyl Overlay

Product: Acrylic Face LED Internally Illuminated Signage

Associate Entry Sign Color: White Acrylic

Product: Acrylic Face LED Internally Illuminated Signage

Customer Service & Package

Pick-Up Vinyl Overlay

Color: White Acrylic and White Acrylic w/ Grey Sign Pick-Up

Product: Acrylic Face LED Internally Illuminated Signage

Pylon Entry Sign Color: Opaque Black Acrylic and Reflective Black Vinyl

Product: Aluminum Sign Connection to Posts


Pylon Placards Color: Opaque Black Acrylic Arrows and Reflective Black Vinyl

Lettering

Product: Placard Connection to Aluminum Sign

Directional Sign Color: White Aluminum Sign Panel w/ Black Vinyl Lettering

Product: Aluminum Sign Connection to Metal U-Channel Posts

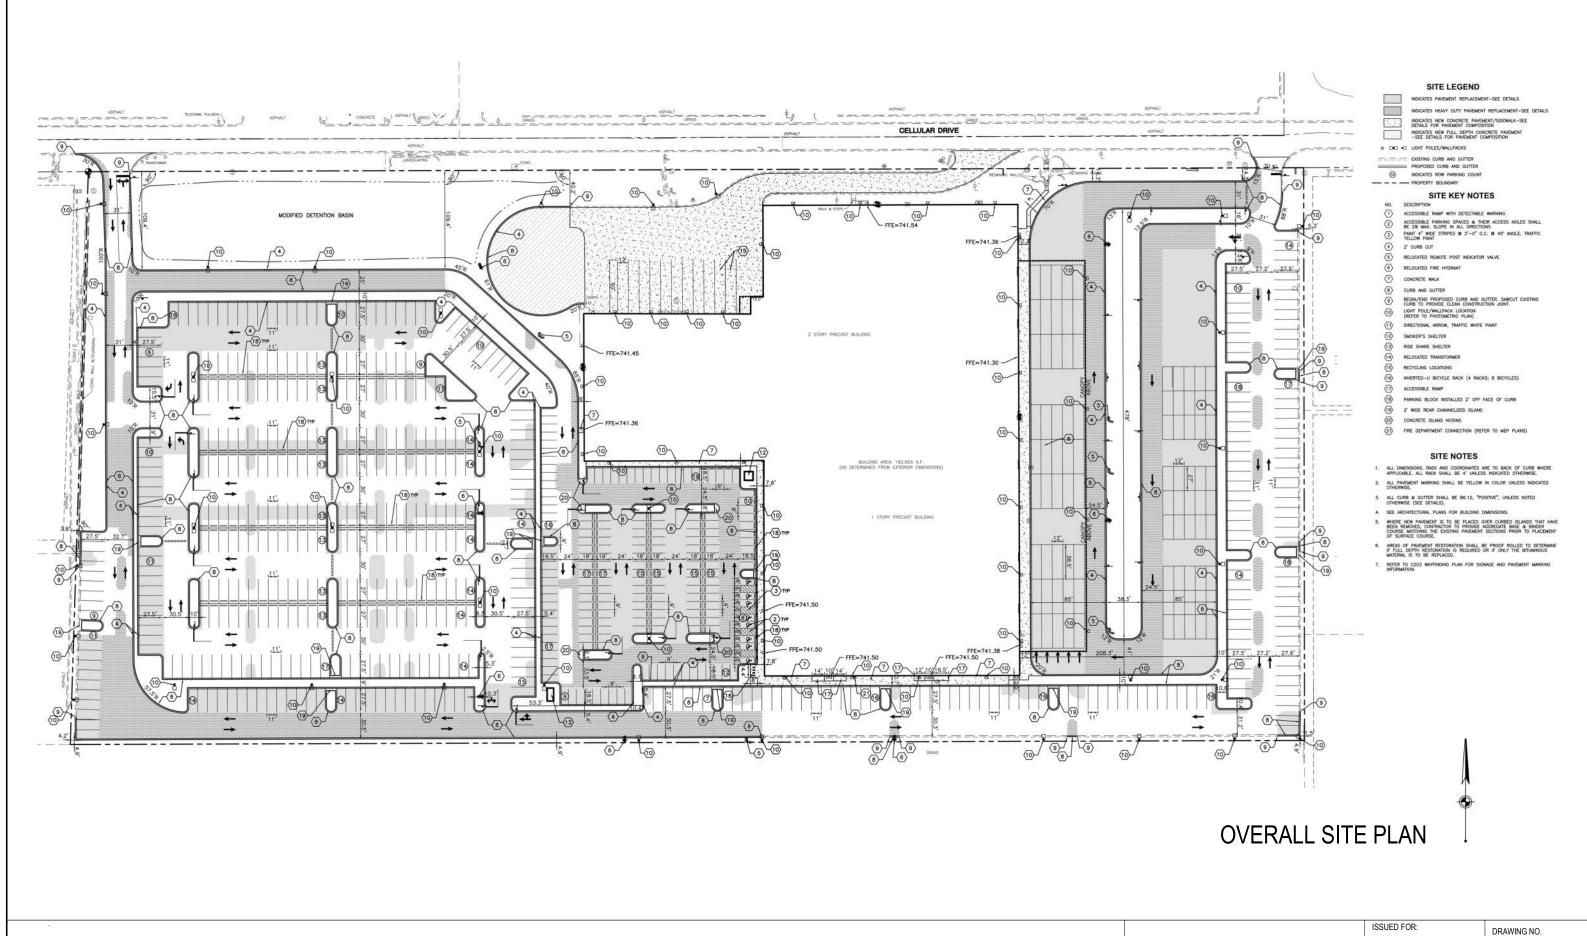

Bowen⁺
2019 Center St., Suite 500 Cleveland, Ohio 44113 Phone; (216) 491-9300 www.rlba.com

__DLN3 - DISTRIBUTION CENTER_ 1455 W. SHURE DRIVE ARLINGTON HEIGHTS, IL 60004

SCALE: N.T.S.


RLB+A JOB#: 13299


SIGN VARIANCE

05/01/20

AS1.01 - SK01

THIS ARCHITECTURAL AND ENGINEERING DRAWING IS GIVEN IN CONFIDENCE. NO USE OR DISSEMINATION MAY BE MADE WITHOUT PRIOR WRITTEN CONSENT OF THE ARCHITECT. ALL RIGHTS ARE HEREBY SPECIFICALLY RESERVED. © 2017 RICHARD L. BOWEN + ASSOCIATES, INC.

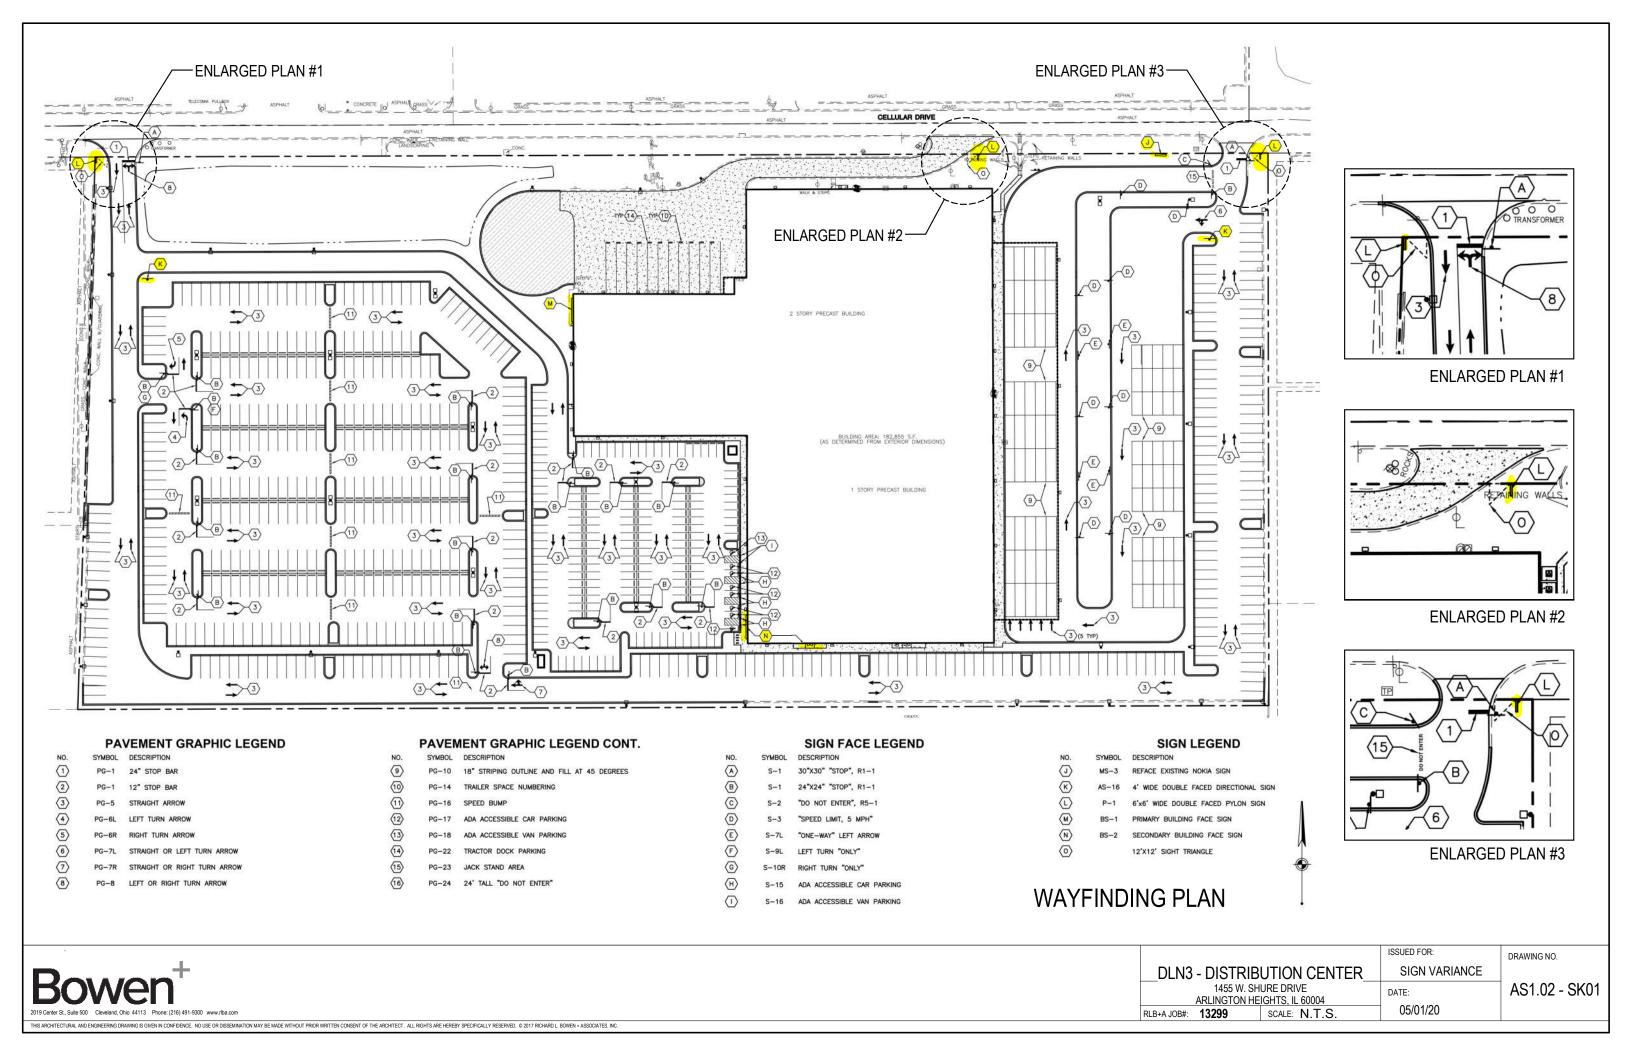

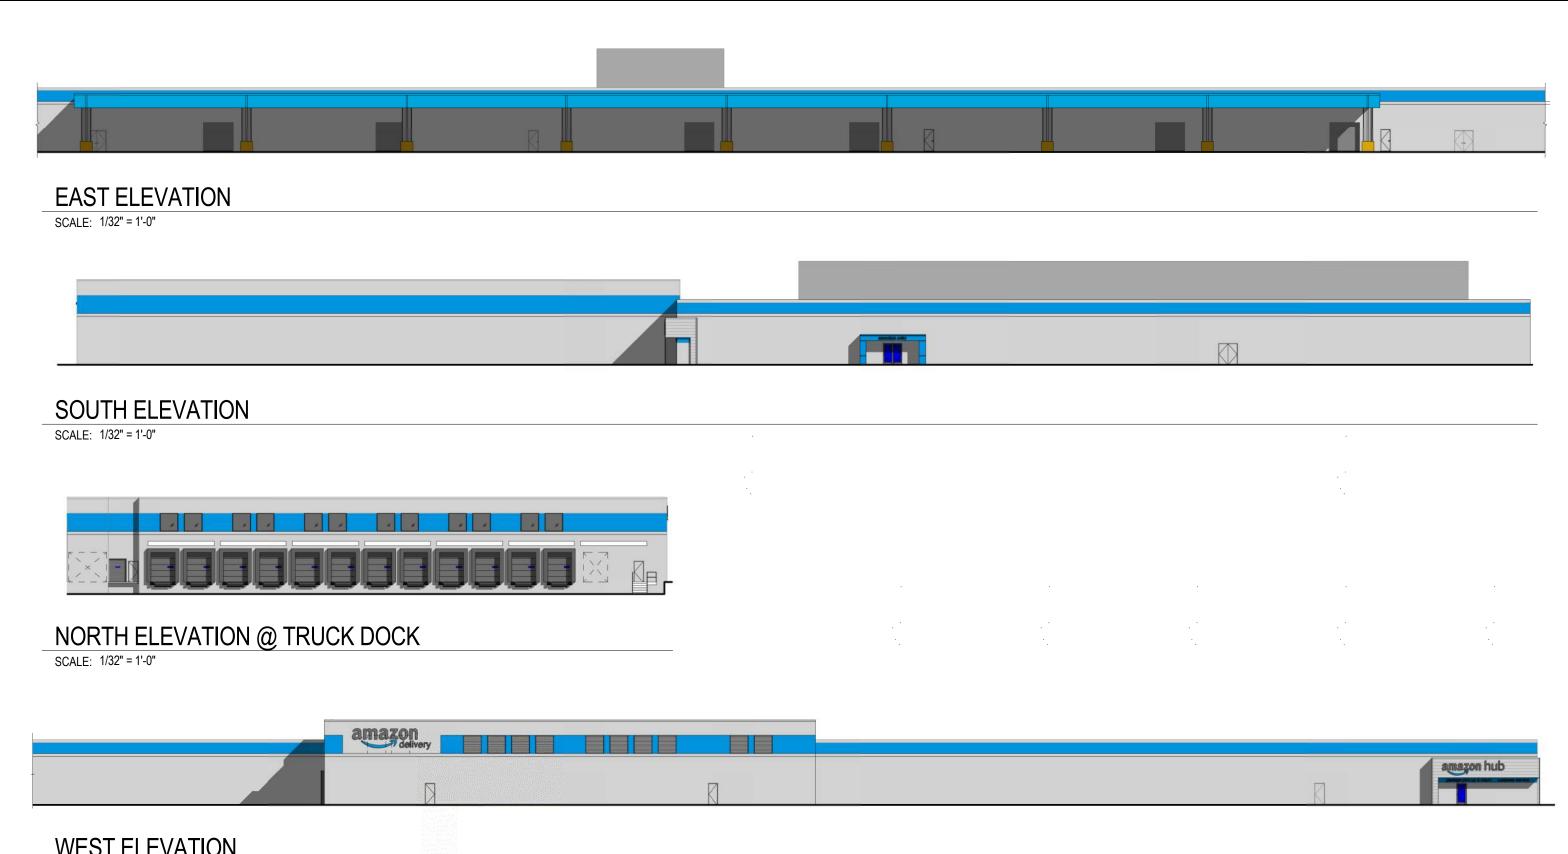

WEST ELEVATION

SCALE: 1/32" = 1'-0"



DLN3 - DISTRIBUTION CENTER 1455 W. SHURE DRIVE

DATE:

DRAWING NO. SIGN VARIANCE


ARLINGTON HEIGHTS, IL 60004 RLB+A JOB#: **13299** SCALE: N.T.S.

AS1.03 - SK01 05/01/20




MAIN BUILDING SIGN ELEVATION

SCALE: 1/8" = 1'-0"

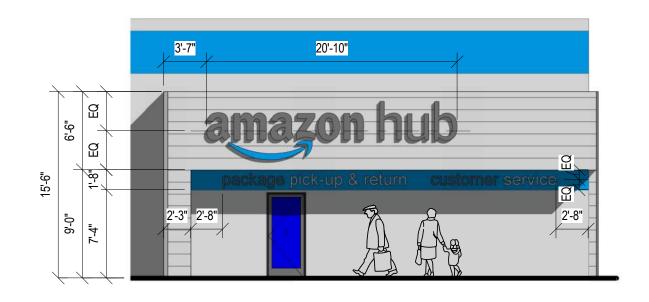

ENLARGED AMAZON HUB

SCALE: 1/8" = 1'-0"

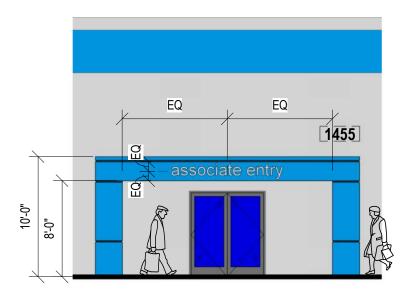

ENLARGED ASSOCIATE ENTRY ELEVATION

SCALE: 1/8" = 1'-0"



DLN3 - DISTRIBUTION CENTER	٠.	
1455 W. SHURE DRIVE		Γ

SIGN VARIANCE

AS1.04 - SK01

DRAWING NO.

+A JOB#: **13299** SCALE: N.T.S.

05/01/20

S ARCHITECTURAL AND ENGINEERING DRAWING IS GIVEN IN CONFIDENCE. NO USE OR DISSEMINATION MAY BE MADE WITHOUT PRIOR WRITTEN CONSENT OF THE ARCHITECT. ALL RIGHTS ARE HEREBY SPECIFICALLY RESERVED. © 2017 RICHARD I. BOWEN + ASSOCIATES, INC.



TYPICAL DELIVERY SIGN DESIGN

TOTAL SF: 138.50


AMAZON FONT SIZE: 39" DELIVERY FONT SIZE: 17"

20'-10"

TYPICAL HUB SIGN DESIGN

TOTAL SF: 78,65

AMAZON FONT SIZE: 27" **HUB** FONT SIZE: 27"

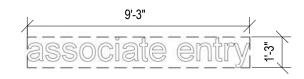

TYPICAL ASSOC. ENTRY SIGN DESIGN

TOTAL SF: 11.95

FONT SIZE: 9"



TYPICAL CUSTOMER SERVICE SIGN DESIGN

TOTAL SF: 35.26

FONT SIZE: 9"

DLN3 - DISTRIBUTION CENTER 1455 W. SHURE DRIVE

ISSUED FOR: SIGN VARIANCE DATE:


05/01/20

AS1.05-SK01

DRAWING NO.



EXISTING MONUMENT SIGN

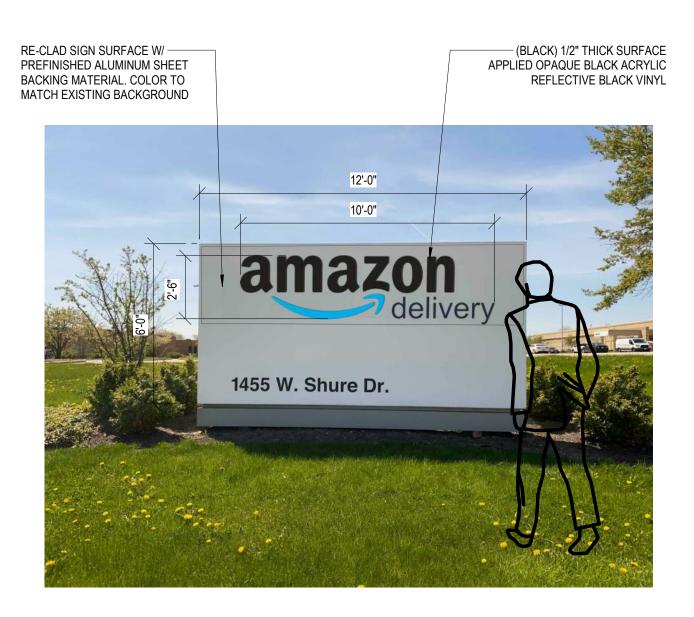

REFACED MONUMENT SIGN

TOTAL SF: 25 SF




ISSUED FOR:
SIGN VARIANCE
DATE:

ARLINGTON HEIGHTS, IL 60004

RLB+A JOB#: 13299 SCALE: N.T.S.

AS1.06-SK01

DRAWING NO.

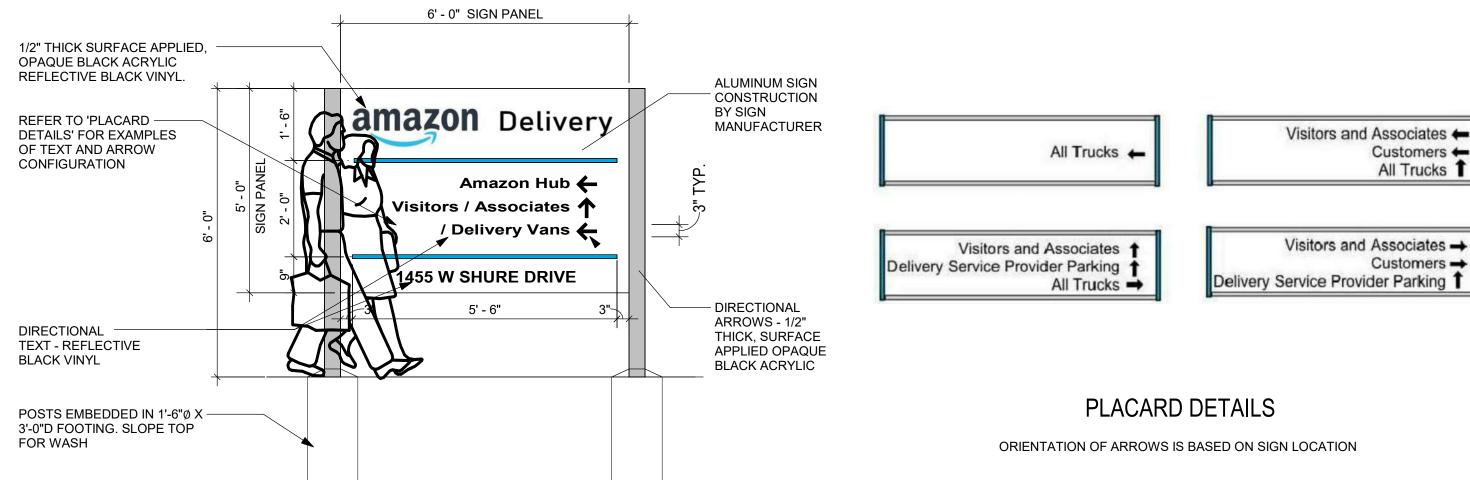

PYLON ENTRY SIGN DESIGN

DIRECTIONAL ARROWS CHANGE BASED ON LOCATIONS OF SIGN

DLN3 - DISTRIBUTION CENTER 1455 W. SHURE DRIVE ARLINGTON HEIGHTS, IL 60004

ISSUED FOR: DRAWING NO. SIGN VARIANCE AS1.07-SK01

Customers -


All Trucks 1

Customers →

DATE: 05/01/20

RLB+A JOB#: **13299**

SCALE: N.T.S.

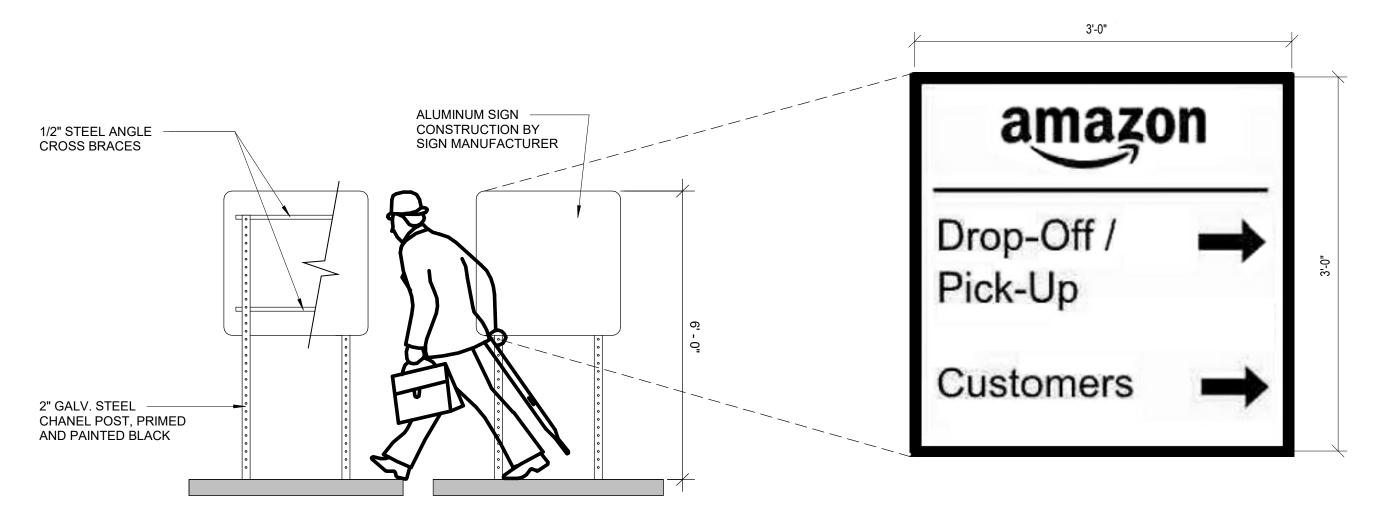

DIRECTIONAL SIGN DESIGN - DOUBLE-SIDED

FACE (BOTH SIDES)

CONSTRUCTION

DIRECTIONAL ARROWS & TEXT CHANGE BASED ON LOCATIONS OF SIGN

DIRECTIONAL SIGNAGE EXAMPLE (AS-16)

Bo	we	\mathbf{n}^{+}	
2019 Center St., Suite 500	Cleveland, Ohio 44113	Phone: (216) 491-9300	www.rlba.co

DLN3 - DISTRIBUTION CENTER	SIGI
1455 W. SHURE DRIVE ARLINGTON HEIGHTS. IL 60004	DATE:
741211101011112101110,12 00001	0-14















A. SITE





B. PROPERTY TO THE EAST







C. PROPERTY TO THE WEST







D. PROPERTY TO THE NORTH



___DLN3 - DISTRIBUTION CENTER_ 1455 W. SHURE DRIVE

1455 W. SHURE DRIVE ARLINGTON HEIGHTS, IL 60004 RLB+A JOB#: **13299** SCALE: **N.T.S.** ISSUED FOR: SIGN VARIANCE

DATE: 05/01/20

AS1.09 - SK01

DRAWING NO.