

30 0 30 60 Scale: 1"=30'

# LEGEND

EXISTING

Manhole

Catch Basin

Area Drain

Co. Clean Out

Flared End Section

Storm Sewer

Sanitary Sewer

Combined Sewer

Water Main

Gas Line

OH Overhead Wires

Electrical Cable (Buried)

Telephone Line

Fire Hydrant

Valve Vault

Buffalo Box

Downspout

Gas Valve

ComEd Manhole

Hand Hole

Light Pole

Utility Pole

Telephone Pedestal

Telephone Manhole

Accessible

Parking Stall

Curb & Gutter

Depressed Curb

X C 782.50

X G 782.00

Gutter Elevation

X 784.0

Top of Retaining Wall Elevation

Swale

Contour Line

Deciduous Tree

Brushline


Brushline

Brushline

Tree Protection
Fencing at Drip Line

# GENERAL NOTES

- 1. The Location of Existing Underground Utilities, Such As Watermains, Sewers, Gas Lines, Etc., As Shown On The Plans, Has Been Determined From The Best Available Information and Is Given For The Convenience of The Contractor. However, The Owner and The Engineer Do Not Assume Responsibility In The Event That During Construction, Utilities Other Than Those Shown May Be Encountered, and That The Actual Location of Those Which Are Shown May Be Different From The Location As Shown On The Drawings. Contact Engineer Immediately If Surface and/or Subsurface Features Are Different Than Shown On The Drawings.
- Notify The Engineer Without Delay of Any Discrepancies Between the Drawings and Existing Field Conditions.
- Notify The Owner, Engineer and The A Minimum of 48 Hours In Advance of Performing Any Work.
- 4. All Areas, On or Off Site, Disturbed During Construction Operations and Not Part of the Work As Shown Hereon Shall Be Restored To Original Condition to the Satisfaction of the Owner at No Additional Cost to the Owner. It is Incumbent Upon Contractor to Show That Damaged Areas Were Not Disturbed By Construction Operations.
- These Drawings Assume That The Contractor Will Utilize An Electronic Drawing File (DWG) and Stake All Site Improvements Accordingly.
- No Person May Utilize The Information Contained Within These Drawings Without Written Approval From Eriksson Engineering Associates, Ltd.
- 7. The Engineer Is Furnishing These Drawings For Construction Purposes As A Convenience To The Owner, Architect, Surveyor, or Contractor. Prior To The Use Of These Drawings For Construction Purposes, The User Of This Media Shall Verify All Dimensions And Locations Of Buildings With The Foundation Drawings And Architectural Site Plan, and Coordinate All Dimensions and Locations of All Site Items. If Conflicts Exist The User Of This Information Shall Contact The Engineer Immediately.
- 8. Provide An As-built Survey Prepared By A Licensed Professional Land Surveyor In Accordance With The Authorities Having Jurisdiction Which May Include All Detention Basins, Including All Storm and Sanitary Sewers and Structure Locations, Sizes, Rim and Invert Elevations, Final Detention Volume Calculations For The Basin(s) and Watermain and Valve and Appurtenance Locations.
- The Illinois Department Of Transportation Standard Specifications For Road And Bridge Construction Latest Edition, And All Addenda Thereto, Shall Govern The Earthwork And Paving Work Under This Contract Unless Noted Otherwise.

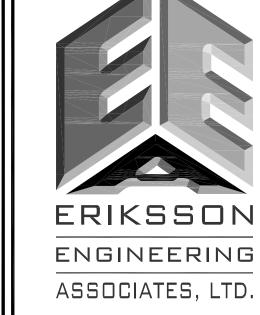

145 COMMERCE DRIVE, SUITE A GRAYSLAKE, ILLINOIS 60030 PHONE (847) 223-4804 FAX (847) 223-4864

EMAIL INFO@EEA-LTD.COM
PROFESSIONAL DESIGN FIRM
LICENSE NO. 184-003220
EXPIRES: 04/30/2017

IVY HILL ELEMENTARY SCHC 2015 BUILDING ADDTION

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Expiration Date:\_\_\_

No.	Date	Description
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Date:

06/06/15

Approved By:

Project No.

KC.


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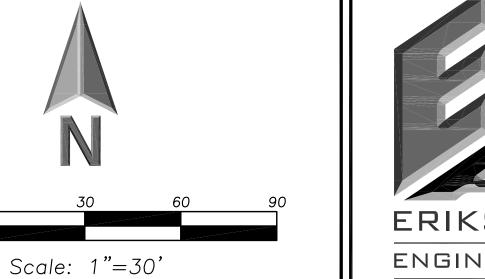
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EEA — P:\Josh\Arlington Heights School Dist 25\Drawings\2015 Ivy Hill Addition—Siteplan Plotted: 7/07/15 @ 12:04nm Bv: ican





Manhole

Catch Basin

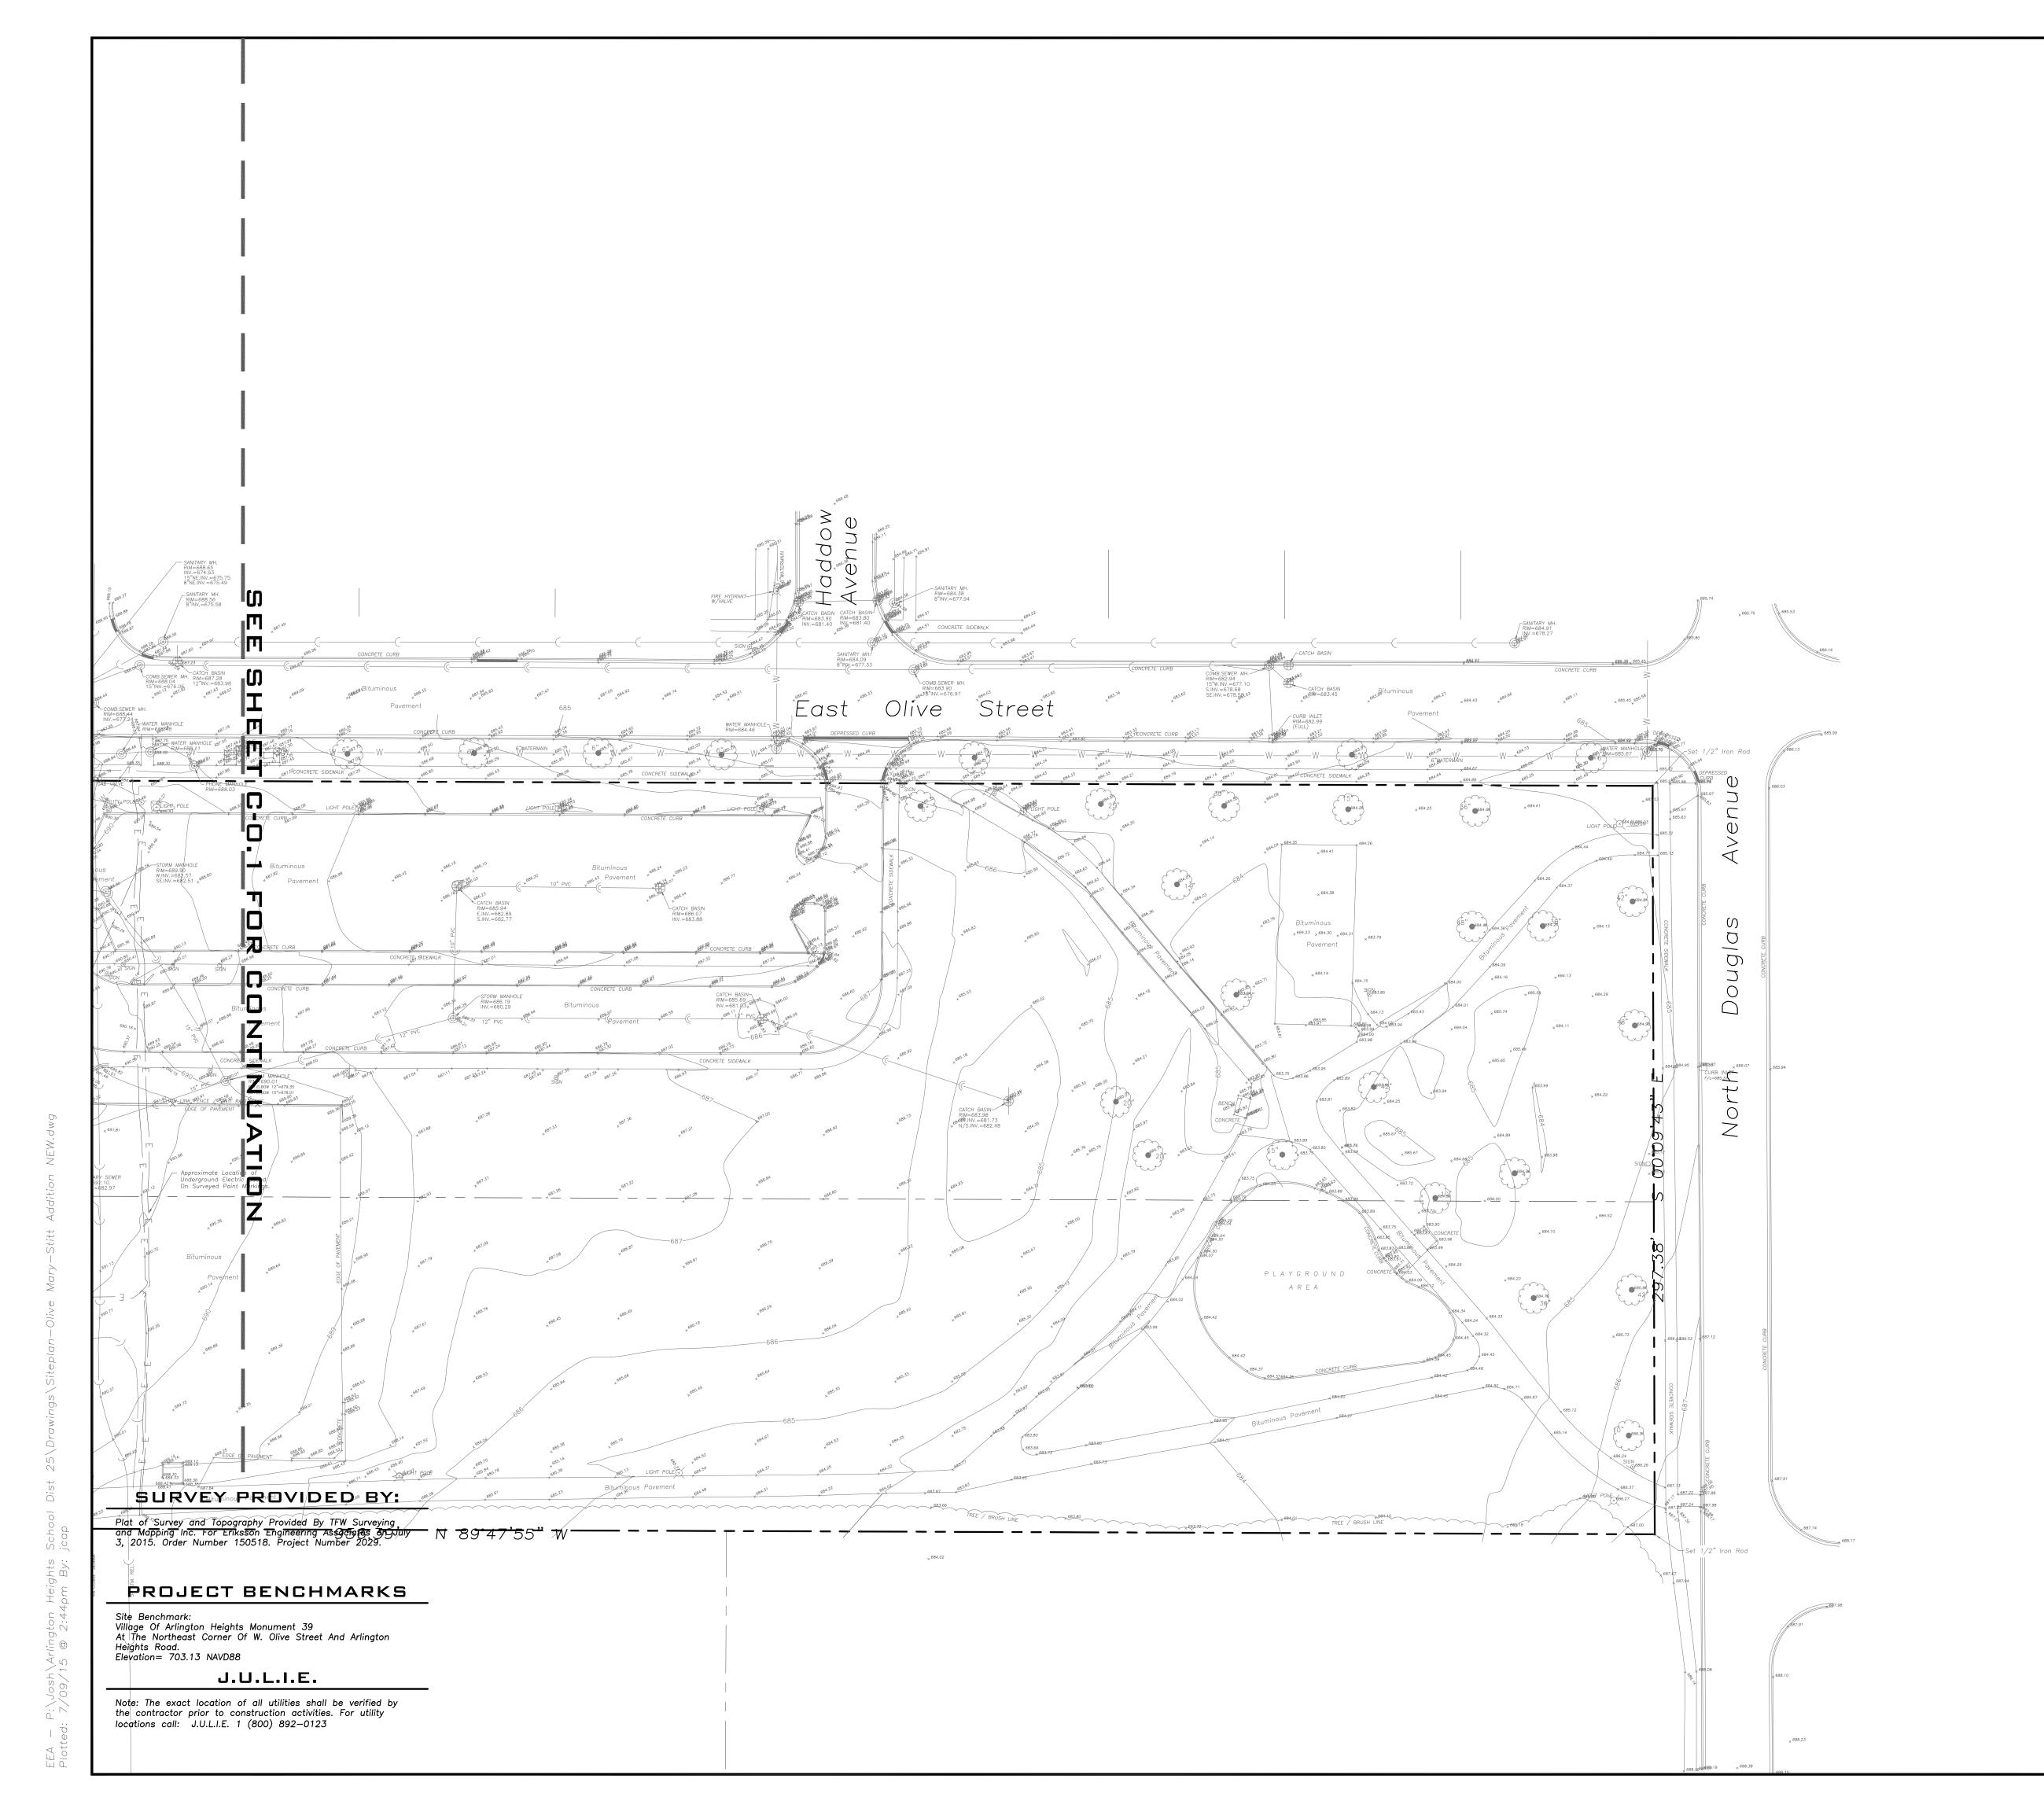Area Drain

Clean Out

Flared End Section

Storm Sewer

Sanitary Sewer

Combined Sewer

Water Main

Gas Line

Overhead Wires

Electrical Cable (Buried)

Telephone Line

Fire Hydrant

Valve Vault

Buffalo Box

Downspout

Gas Valve

ComEd Manhole

Hand Hole

Light Pole

Utility Pole

Utility Pole

Telephone Manhole

Sign

Fence

Accessible Parking Stall

Curb & Gutter


Depressed Curb

# GENERAL NOTES

Tree Protection Fencing at Drip Line

Contour Line
Deciduous Tree

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- 4. All Areas, On or Off Site, Disturbed During Construction Operations and Not Part of the Work As Shown Hereon Shall Be Restored To Original Condition to the Satisfaction of the Owner at No Additional Cost to the Owner. It is Incumbent Upon Contractor to Show That Damaged Areas Were Not Disturbed By Construction Operations.
- These Drawings Assume That The Contractor Will Utilize An Electronic Drawing File (DWG) and Stake All Site Improvements Accordingly.
- No Person May Utilize The Information Contained Within These Drawings Without Written Approval From Eriksson Engineering Associates, Ltd.
- 7. The Engineer Is Furnishing These Drawings For Construction Purposes As A Convenience To The Owner, Architect, Surveyor, or Contractor. Prior To The Use Of These Drawings For Construction Purposes, The User Of This Media Shall Verify All Dimensions And Locations Of Buildings With The Foundation Drawings And Architectural Site Plan, and Coordinate All Dimensions and Locations of All Site Items. If Conflicts Exist The User Of This Information Shall Contact The Engineer Immediately.
- 8. Provide An As-built Survey Prepared By A Licensed Professional Land Surveyor In Accordance With The Authorities Having Jurisdiction Which May Include All Detention Basins, Including All Storm and Sanitary Sewers and Structure Locations, Sizes, Rim and Invert Elevations, Final Detention Volume Calculations For The Basin(s) and Watermain and Valve and Appurtenance Locations.
- The Illinois Department Of Transportation Standard Specifications For Road And Bridge Construction Latest Edition, And All Addenda Thereto, Shall Govern The Earthwork And Paving Work Under This Contract Unless Noted Otherwise.

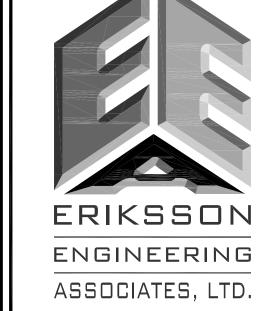

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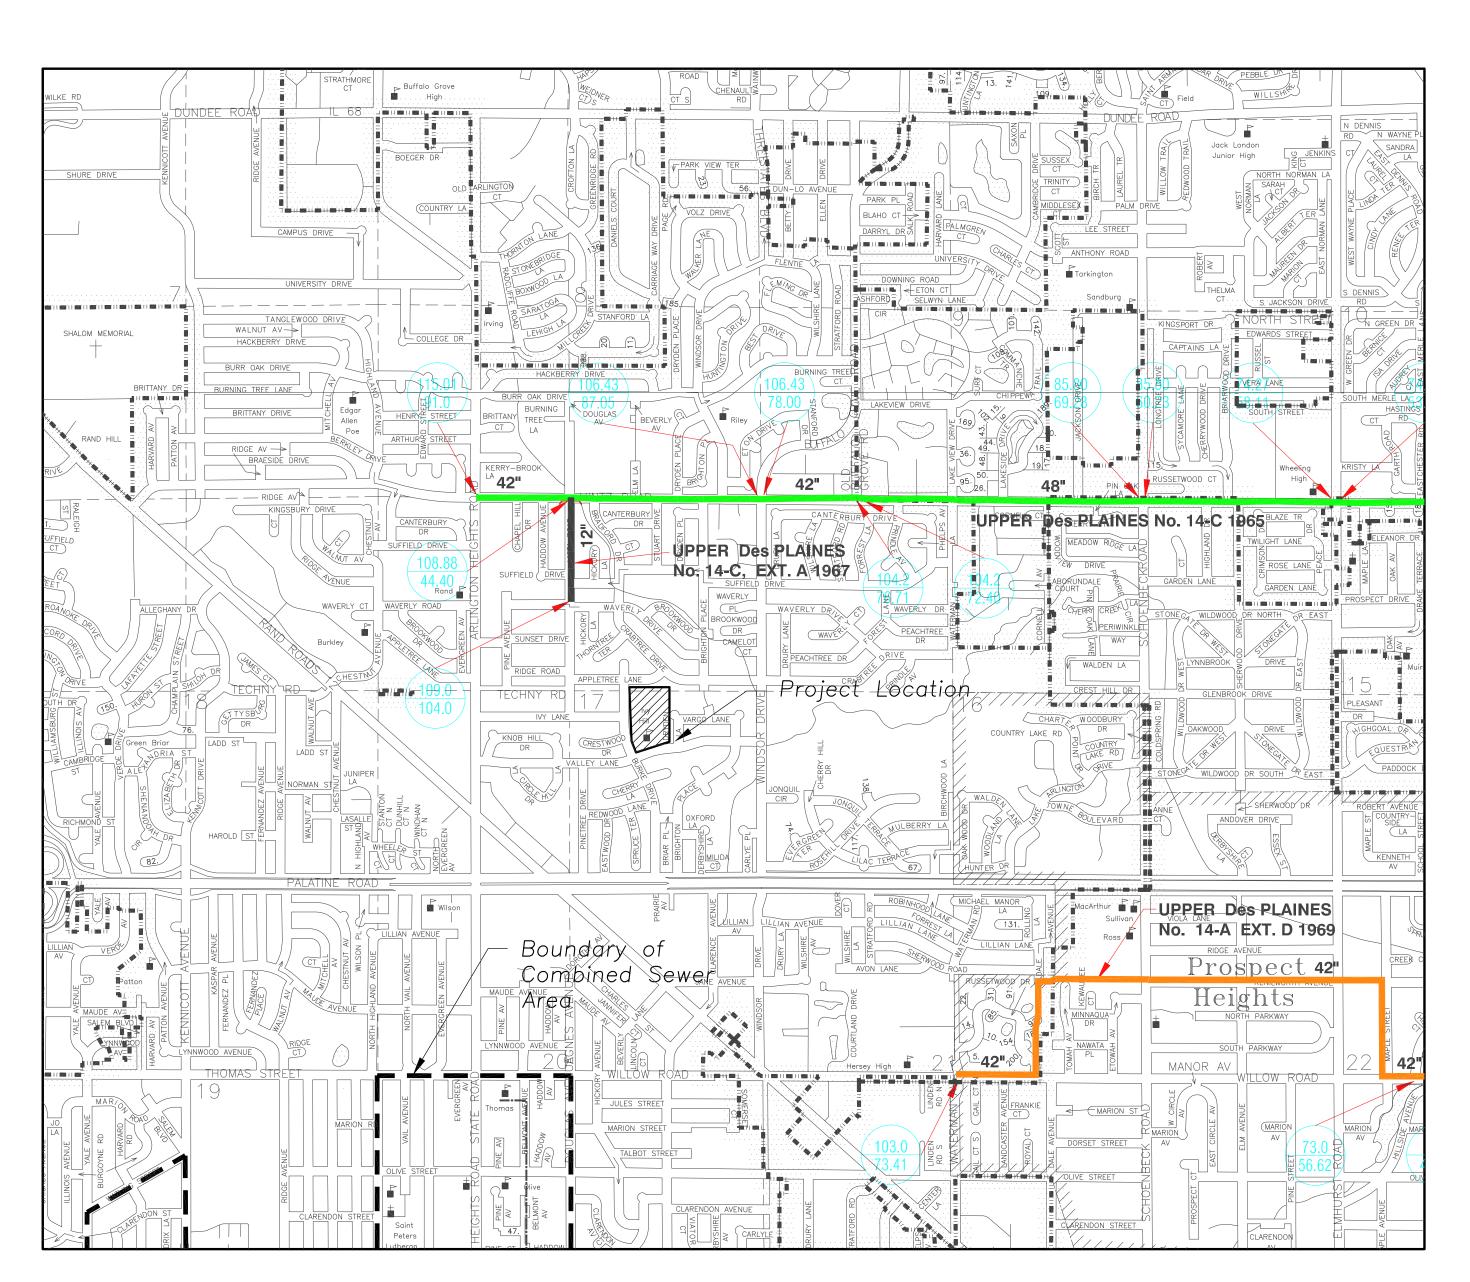
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# IVY HILL ELEMENTARY SCHOOL ADDITION AND RENOVATIONS

2211 N. Burke Dr. Arlington Heights, IL 60004





# SHEET INDEX

-0.0 Cover Sheet
-0.1 General Notes
-1.1 Site Demolition Plan
-2.1 Site Geometry Plan
-3.1 Site Utility Plan
-4.1 Grading and Paving Plan
-5.1 Soil Erosion and Sediment Control Plan

C-6.1 Site Details
CX-7.1 Autoturn Exhibit
CX-7.2 Project Disturbance
TP100 Tree Preservation Plan
L100 Landscape Plan

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COVER SHEET

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# SURVEY PROVIDED BY:

Plat of Survey and Topography Provided By TFW Surveying and Mapping Inc. For Eriksson Engineering Associates on July 3, 2015. Order Number 150518. Project Number 2029.

# PROJECT BENCHMARKS

1. Site Benchmark 1, Flange Bolt FH Elevation=686.60 2. Site Benchmark 1, Arrow Bolt FH Elevation=686.15

# J.U.L.I.E.

Note: The exact location of all utilities shall be verified by the contractor prior to construction activities. For utility locations call: J.U.L.I.E. 1 (800) 892—0123

To The Best Of Our Knowledge And Belief, It Is Our Professional Opinion That The Proposed
Improvements On The Property Are Not Within One—Hundred (100) Feet Of A Known Flood
Protection Area. The Drainage Of The Surface Waters Will Not Be Changed By The
Construction Of This Development Or Any Part Thereof, Or That If Such Surface Water
Drainage Will Be Changed, Reasonable Provisions Have Been Made For The Collection And
Diversion Of Such Surface Waters Into Public Areas Or Drains Which The Property Owner Has
A Right To Use, And That Such Surface Waters Will Be Planned For In Accordance With
Generally Accepted Engineering Practices So As To Reduce The Likelihood Of Damage To The
Adjoining Property Because Of The Construction Of The Development.

# **DEMOLITION NOTES**

- 1. All Signs to Be Removed Shall Be Salvaged and Stored in the Owner's Facility for Future Use as Applicable.
- 2. Keep All Village Of Arlington Heights Streets Free and Clear of Construction Related Dirt/Dust/Debris.
- 3. Coordinate Existing Utility Removal with Local Authorities and Utility Companies Having Jurisdiction.
- 4. Coordinate Removal of Overhead Wires And Utility Poles With Authorities Having Jurisdiction And Respective Utility
- 5. The Existing Building is to Remain Operational During Construction. Therefore, the Temporary Relocation of All Necessary Utilities Serving the Existing Building Shall Be Coordinated Prior to the Commencement of Construction
- 6. All Sawcutting Shall be Full Depth to Provide a Clean Edge to Match New Construction. Match Existing Elevations at Points of Connection for New and Existing Pavement, Curb, Sidewalks, etc. All Sawcut Locations Shown Are Approximate and May Be Field Adjusted to Accommodate Conditions, Joints, Material Type, etc. Remove Minimum Amount Necessary for Installation of Proposed Improvements.
- 7. Provide and Maintain All Necessary Traffic Control and Safety Measures Required During Demolition and Construction Operations Within or Near the Public Roadway.
- 8. Perform Tree Pruning In All Locations Where Proposed Pavement And/Or Utility Installation Encroach Within The Existing Drip Line Of Trees To Remain. All Trenching Within The Drip Line Of Existing Trees To Remain Shall Be Done Radially Away From Trunk If Roots In Excess Of 1" Diameter Are Exposed. Roots Must Be Cut By Reputable Tree Pruning Service Prior To Any Transverse Trenching. Obtain Approval Of The Architect Prior To Operations For A Variance From This Procedure.
- 9. Coordinate Tree Removal with Landscape Architect. All Trees To Be Removed Shall Be Removed In Their Entirety and Stumps Shall Be Ground to Proposed Subgrade. Use As Mulch for Proposed Landscaping Where Applicable and Acceptable to Architect.
- 10. Provide Tree Protection Fencing Prior To Construction Operations. Maintain Throughout Construction.

## **GEOMETRY NOTES**

- 1. All Dimensions Contained Herein Reference Back Of Curb, Face Of Retaining Wall, Edge Of Pavement, Center of Structure And Outside Face Of Building Foundation Unless
- 2. All Pavement Striping Shall Be 4" Wide Yellow Paint Per Specifications. All Cross Hatch Striping Shall Be 45° At 2'-0" Centers.
- 3. All Accessible Parking Signs (R7-8) Must Be Placed at the Center of the Space and Within 5 Feet of the Space.
- 4. Refer to Architectural Drawings for Exact Locations of All Buildinas.
- 5. Refer to Architectural Drawings for Locations and Details of All Permanent Site Fencing.

# **GRADING NOTES**

- 1. The Grading and Construction of Proposed Improvements Shall Be Done In A Manner Which Will Allow For Positive Drainage, and Not Cause Ponding of Stormwater on the Surface of Proposed Improvements.
- Respread With 6 Inches (Min.) to 12 Inches (Max.) Topsoil and **Sod** Unless Noted Otherwise On The Landscape

2. All Landscaped Areas Disturbed By Construction Shall Be

- 3. Refer to Architectural Drawings for Locations and Patterns of Expansion and Control Joints in Concrete Pavement and
- 4. Accessible Parking Spaces and Loading Spaces Shall Be Sloped at Maximum 2.0% in Any Direction. Maximum Sidewalk Cross Slopes Shall be 2.0%. Maximum Longitudinal Sidewalk Slope Shall Be 4.9%. Contact Engineer if Conflicts Exist.

## UTILITY NOTES

- 1. Utility Service Lines as Shown Hereon are Approximate. Coordinate The Exact Locations With The Plumbing Drawings. Coordinate The Locations With The Plumbing Contractor and/or the Owner's Construction Representative Prior to Installation of Any New Utilities.
- 2. Refer to Plumbing Drawings for Continuation of All Utilities Within 5 Feet of Building Face.
- 3. Field Verify Invert & Locations of Existing Utility Mains Prior to Installing Any On-Site Utilities or Structures. All Elevations and Invert's Referencing Said Utility Shall Be Field Verified Prior To Installation Of Any New Structures Or Utilities, and Adjustments Shall Be Made as Necessary. Contact Engineer Prior to Installation if Discrepancy Exists With These Drawings.
- 4. Coordinate the Relocation Of Any Utilities Encountered And Replacement Of Any Utilities Damaged Within Influence Zone Of New Construction. Contact Engineer If The Existing Utilities Vary Appreciably From The Plans.
- 5. All Water Main and Services Shall Be Installed at a Minimum Depth of 5.5' From Top of Finished Ground Elevation to Top of Main.
- 6. Protection of water supplies shall be as described in Section 370.350 of the Illinois Recommended 7. Standards for Sewage Works or Section 41-2.01 of the Standard Specifications for Water and Sewer Main Construction in Illinois, latest edition.
- 8. Clean Out All Existing and Proposed Storm Inlets and Catch Basins at the Completion of Construction.
- 9. The "Standard Specifications for Water and Sewer Main Construction in Illinois", Current Edition Shall Govern Work Where Applicable.

## STRUCTURE NOTES

- 1. All Catch Basins to Be Installed in Paved Areas Shall Have Neenah R2504-D Frame & Grate or Approved Equal.
- 2. All Catch Basins to Be Installed in Landscaped Areas Shall Have Neenah R4340-B Frame & Grate or Approved Equal. For Cone Sections Install a Minimum of 4" Grade Rings For Topsoil Respread. For Flat Slab Tops Install the Following Minimum Height of Grade Rings: 4' Diameter Structure- 4" 5' Diameter Structure- 6" 6' Diameter Structure- 8"
- 3. All Catch Basins to Be Installed Along Curb and Gutter (B-6.12) Shall Have Neenah R3281-A Frame & Grate or Approved Equal.
- 4. All Catch Basins to Be Installed Along Depressed Curb and Gutter (Dep B-6.12) Shall Have East Jordan Iron Works 5120 Catch Basin Inlet Frame and Grate, or Approved
- Where Structures are Shown Along the Curbline, Unless Specifically Stated Otherwise, It Is Intended That the Frame of the Structure Is To Fall Within the Flowline Of The Gutter or at the Pavement Edge Where No Gutter Exists.
- 6. All Manholes Shall Have Neenah R1713-B Frame & Closed Lid or Approved Equal, with "Storm" or "Sanitary" Imprinted as Appropriate
- 7. For All Manhole Structures to Be Adjusted, Install or Remove Adjusting Rings, New Cone Section or New Barrel
- 8. All Sanitary Manholes Shall Include a Chimney Seal.

# INTENDED SEQUENCE OF MAJOR SEDIMENT AND EROSION CONTROL MEASURES

- . Install Stabilized Construction Entrance 2. Install All Downslope and Sideslope Perimeter Controls
- Before Commencement of Any Ground Disturbing Activity. 3. Do Not Disturb An Area Until It Is Necessary For
- Construction To Proceed. 4. Cover and Stabilize Disturbed Areas As Soon As Possible.
- 5. When Practical, Time Construction Activities To Limit Impact From Seasonal Climate Changes or Weather Events. 6. Perform Grading Operations and Installation of Site
- Infrastructure and Pavement. 7. Install Permanent Seeding and Plantings. 8. Remove Accumulated Sediment From Basins and Along Silt
- 9. Construction of Infiltration Measures Shall Take Place Following Stabilization of Upstream Drainage Areas. 10. Remove Temporary Sediment and Erosion Control Measures Following Final Stabilization of All Disturbed Areas.

## SOIL EROSION & SEDIMENTATION CONTROL

# NOTES

- 1. Illinois Urban Manual Shall Govern All Soil Erosion and Sediment Control, and Related Work.
- 2. Contractor Shall Be Responsible for Compliance With IEPA NPDES and ILR10 Permit Requirements for Project.
- 3. Soil Disturbance Shall Be Conducted in Such a Manner as To Minimize Erosion. Soil Stabilization Measures Shall Consider the Time of Year, Site Conditions, and the Use of Temporary or Permanent Measures.
- 4. Soil Erosion and Sediment Control Features Shall Be Constructed Prior to the Commencement of Upland Disturbance.
- 5. Temporary Soil Stabilization Shall Be Applied to Topsoil Stockpiles and Disturbed Areas, Where Construction Activity Will Not Occur For A Period of More Than 14 Calendar Days, Temporary Measures Shall Be Applied Within 7 Calendar Days of the End of Active Hydrologic Disturbance The Sediment Control Measures Shall Be Maintained On A Continuing Basis Until The Site Is Permanently Stabilized And All Inspections Are Complete. Permanent Stabilization Shall Be Completed Within 14 Days after Completion of Final Grading of Soil.
- 6. All Temporary And Permanent Erosion Control Measures Shall Be Removed Within 30 Days After Final Site Stabilization Is Achieved Or After The Temporary Measures Are No Longer Needed. Trapped Sediment And Other Disturbed Soil Areas Shall Be Permanently Stabilized.
- 7. Final Site Stabilization Is Defined By The EPA General Permit As Meaning That All Soil Disturbing Activities At The Site Have Been Completed, And That A Uniform Perennial Vegetative Cover With A Density Of 70 Percent Of The Cover For Unpaved Areas Not Covered By Permanent Structures Has Been Established Or Equivalent Permanent Stabilization Measures (Such As The Use Of Riprap, Gabions, Or Geotextiles) Have Been Employed.
- 8. All Storm Sewer Structures That Are, Or Will Be, Functioning During Construction Shall Be Protected, Filtered, Or Otherwise Treated To Remove Sediment. The General Contractor Shall Use "Catch-All" Inlet Protectors (or equal) and Filter Wattles Around The Grate In Landscaped Areas And "Catch-All" Inlet Protectors (or equal) In Paved Areas To Prevent Siltation.
- 9. All Storm Sewer Structures That Are, Or Will Be, Functioning During Construction Shall Be Protected, Filtered, Or Otherwise Treated To Remove Sediment. The General Contractor Shall Use and Maintain "Dandy Pop" Inlet Protectors (or equal) and Filter Wattles Around The Grate In Landscaped Areas And "Catch—All" Inlet Protectors (or equal, such as Pork Chop Sediguard) In Paved Areas To Prevent Siltation and Discharge Into Waterways.
- 10. All Temporary And Permanent Sediment And Erosion Control Measures Must Be Maintained, Repaired, And Inspected In Conformance With All Applicable IEPA-NPDES Phase II And Lake County DECI Requirements.
- 11. Following The Termination Of Construction Activities And Issuance Of The Required "Notice Of Termination", The Permittees Must Keep A Copy Of The Storm Water Pollution Prevention Plan, Inspection Reports, And Records Of All The Data Used To Complete The Notice Of Intent For A Period Of At Least Three Years Following Final
- 12. Install And Maintain Silt Fence At The Perimeter Of The Construction Zone And Wetland Areas And As Shown On The Plans, Maintain Silt Fence Throughout Construction And Until Vegetation Has Been Fully Established.
- 13. Contractor Shall Provide Qualified Soil Erosion and Sediment Control Inspector Services in Accordance with NPDES and Governmental Requirements. Inspections Shall Occur at Every Seven Calendar Days Or Within 24 Hours of a 0.5" or Greater Rainfall Event. Engineer Shall Be Copied on Inspection Logs.
- 14. The Erosion Control Measures Indicated On The Drawings Are The Minimum Requirements. Additional Measures May Be Required As Directed By The Qualified Soil and Erosion Sediment and Control Inspector Or Governing Agency.
- 15. Unless Otherwise Indicated on the Drawings, Stabilize All Disturbed Ground Areas Where Slopes Exceed 6:1 or Within Swales with North American Green BioNet SC150BN Erosion Control Blanket, or Approved Equal.
- 16. Report Releases of Reportable Quantities of Oil or Hazardous Materials If They Occur In Accordance with IEPA NPDES Requirements.
- 17. All Concrete Washout Shall Conform To The "Temporary Concrete Washout Facility" Standards (Code 954) of the Illinois Urban Manual, Latest Edition.
- 18. If Necessary, The SWPPP Shall Be Modified To Reflect Changes Required During The Effective Period Of The IEPA NPDES General Permit No ILR10 and Local and County
- 19. Dewatering of Excavations Shall be Performed in a Manner Such as Through the use of Filter Bags or Polymer Treated Dewatering Swales, so as to Not Discharge Sediment Laden Water Into Storm Sewers Tributary to

# MWRDGC GENERAL NOTES

- 1. The MWRDGC Local Sewers Field Office Must Be Notified At Least Two (2) Working Days Prior To The Commencement Of Work. Call (708) 588-4055.
- 2. Elevation Datum Is NAVD88.
- 3. All Floor Drains Shall Discharge To The Sanitary Sewer
- 4. All Downspouts And Footing Drains, Shall Discharge To The
- 5. All Sanitary Sewer Pipe Materials (And Storm Sewer Pipe Material In Combined Sewer Areas) And Joints Shall Conform To:
- A. Ductile Iron Pipe (DIP): Pipe Shall Conform To ANSI-21.51 CL52 Cement Lined Per ANSI A-21.4
- 1) Joints: O-Ring, ANSI-21.11 B. Vitrified Clay Pipe (VCP): Pipe Shall Conform To ASTM

1) Joints Shall Conform To ASTM C-425.

- C. Reinforced Concrete Pipe (RCP): Pipe Shall Conform To 1) Joints Shall Conform To ASTM C-443
- D. Polyvinyl Chloride Pipe (PVC 6"-15"dia.-sdr 26): Pipe Shall Conform To ASTM D-3034 1) Joints Shall Conform To Astm D 3212.
- E. Polyvinyl Chloride Pipe (PVC-C900): Pipe Shall Conform To AWWA Ć-900-97 1) Joints Shall Conform To ASTM D-3139.
- 6. All Sanitary Sewer Construction (And Storm Sewer Construction In Combined Sewer Areas): Requires Stone Bedding 1/4" To 1" In Size, With A Minimum Bedding Thickness Equal To 1/4 The Outside Diameter Of The Sewer Pipe, But Not Less Than Four (4) Inches Nor More Than Eight (8) Inches. Material Shall Be CA-11 Or CA-13 And Shall Be Extended At Least 12 Inches Above The Top Of The Pipe When Using PVC.
- 7. "Band Seal" Or Similar Flexible—type Couplings Shall Be Used In The Connection Of Sewer Pipe Of Dissimilar Materials
- 8. When Connecting To An Existing Sewer Main By Means Other Than An Existing Wye, Tee, Or An Existing Manhole, One Of The Following Methods Shall Be Used:
- A. Circular Saw-Cut Of The Storm Sewer Main By Proper Tools ("Sewer-Tap" Machine Or Similar) And Proper Installation Of Hub-Wye Saddle Or Hub-Tee Saddle.
- B. Remove An Entire Section Of Pipe (Breaking Only The Top Of One Bell) And Replace With A Wye Or Tee Branch Section.
- C. With Pipe Cutter, Neatly And Accurately Cut Out Desired Length Of Pipe For Insertion Of Proper Fitting, Using "Band-Seal" Or Similar Couplings To Hold It Firmly In Place.
- 9. Whenever A Sanitary/combined Sewer Crosses Under A Watermain, The Minimum Vertical Distance From The Top Of The Sewer To The Bottom Of The Water Main Shall Be 18 Inches. Furthermore, A Minimum Horizontal Distance Of 10 Feet Between Sanitary/combined Sewers And Water Mains Shall Be Maintained Unless: The Sewer Is Laid In A Separate Trench, Keeping A Minimum 18" Vertical Separation; Or The Sewer Is Laid In The Same Trench With The Water Main Located On The Opposite Side On A Bench Of Undisturbed Earth, Keeping A Minimum 18" Vertical Separation. <u>If Either The Vertical Or Horizontal Distances</u> Described Cannot Be Maintained, Or The Sewer Crossed Above The Water Main, The Sewer Shall Be Constructed To Water Main Standards. All Sanitary Sewers Shall Be Tested In Keeping With All MWRDGC Requirements.
- 10. All Existing Septic Systems To Be Abandoned. Abandoned Tanks To Be Filled With Granular Material Or Removed.
- 11. All Sanitary Manholes, (and Storm Manholes In Combined Sewer Areas), Shall Have A Minimum Inside Diameter Of 48 Inches, And Shall Be Cast In Place Or Pre-cast Reinforced Concrete. Resilient Connectors, Conforming To ASTM C-923, Shall Be Used Between Manhole And Pipes.
- 12. Except For Foundation/footing Drains Provided To Protect Buildings, Drain Tiles/field Tiles/underdrains/perforated Pipes Are Not Allowed To Be Connected Or To Be Tributary To Combined Sewers, Sanitary Sewers, Or Storm Sewers Tributary To Combined Sewers In Combined Sewer Areas. Construction Of New Facilities Of This Type Is Prohibited: And All Existing Drain Tiles And Perforated Pipes Encountered Within The Project Area Shall Be Plugged Or Removed And Shall Not Be Connected To Combined Sewers, Sanitary Sewers, Or Storm Sewers Tributary To Combined
- 13. All Abandoned Sewers Shall Be Plugged At Both Ends With A Minimum Of Two (2) Foot Long Non-shrink Concrete/Mortar



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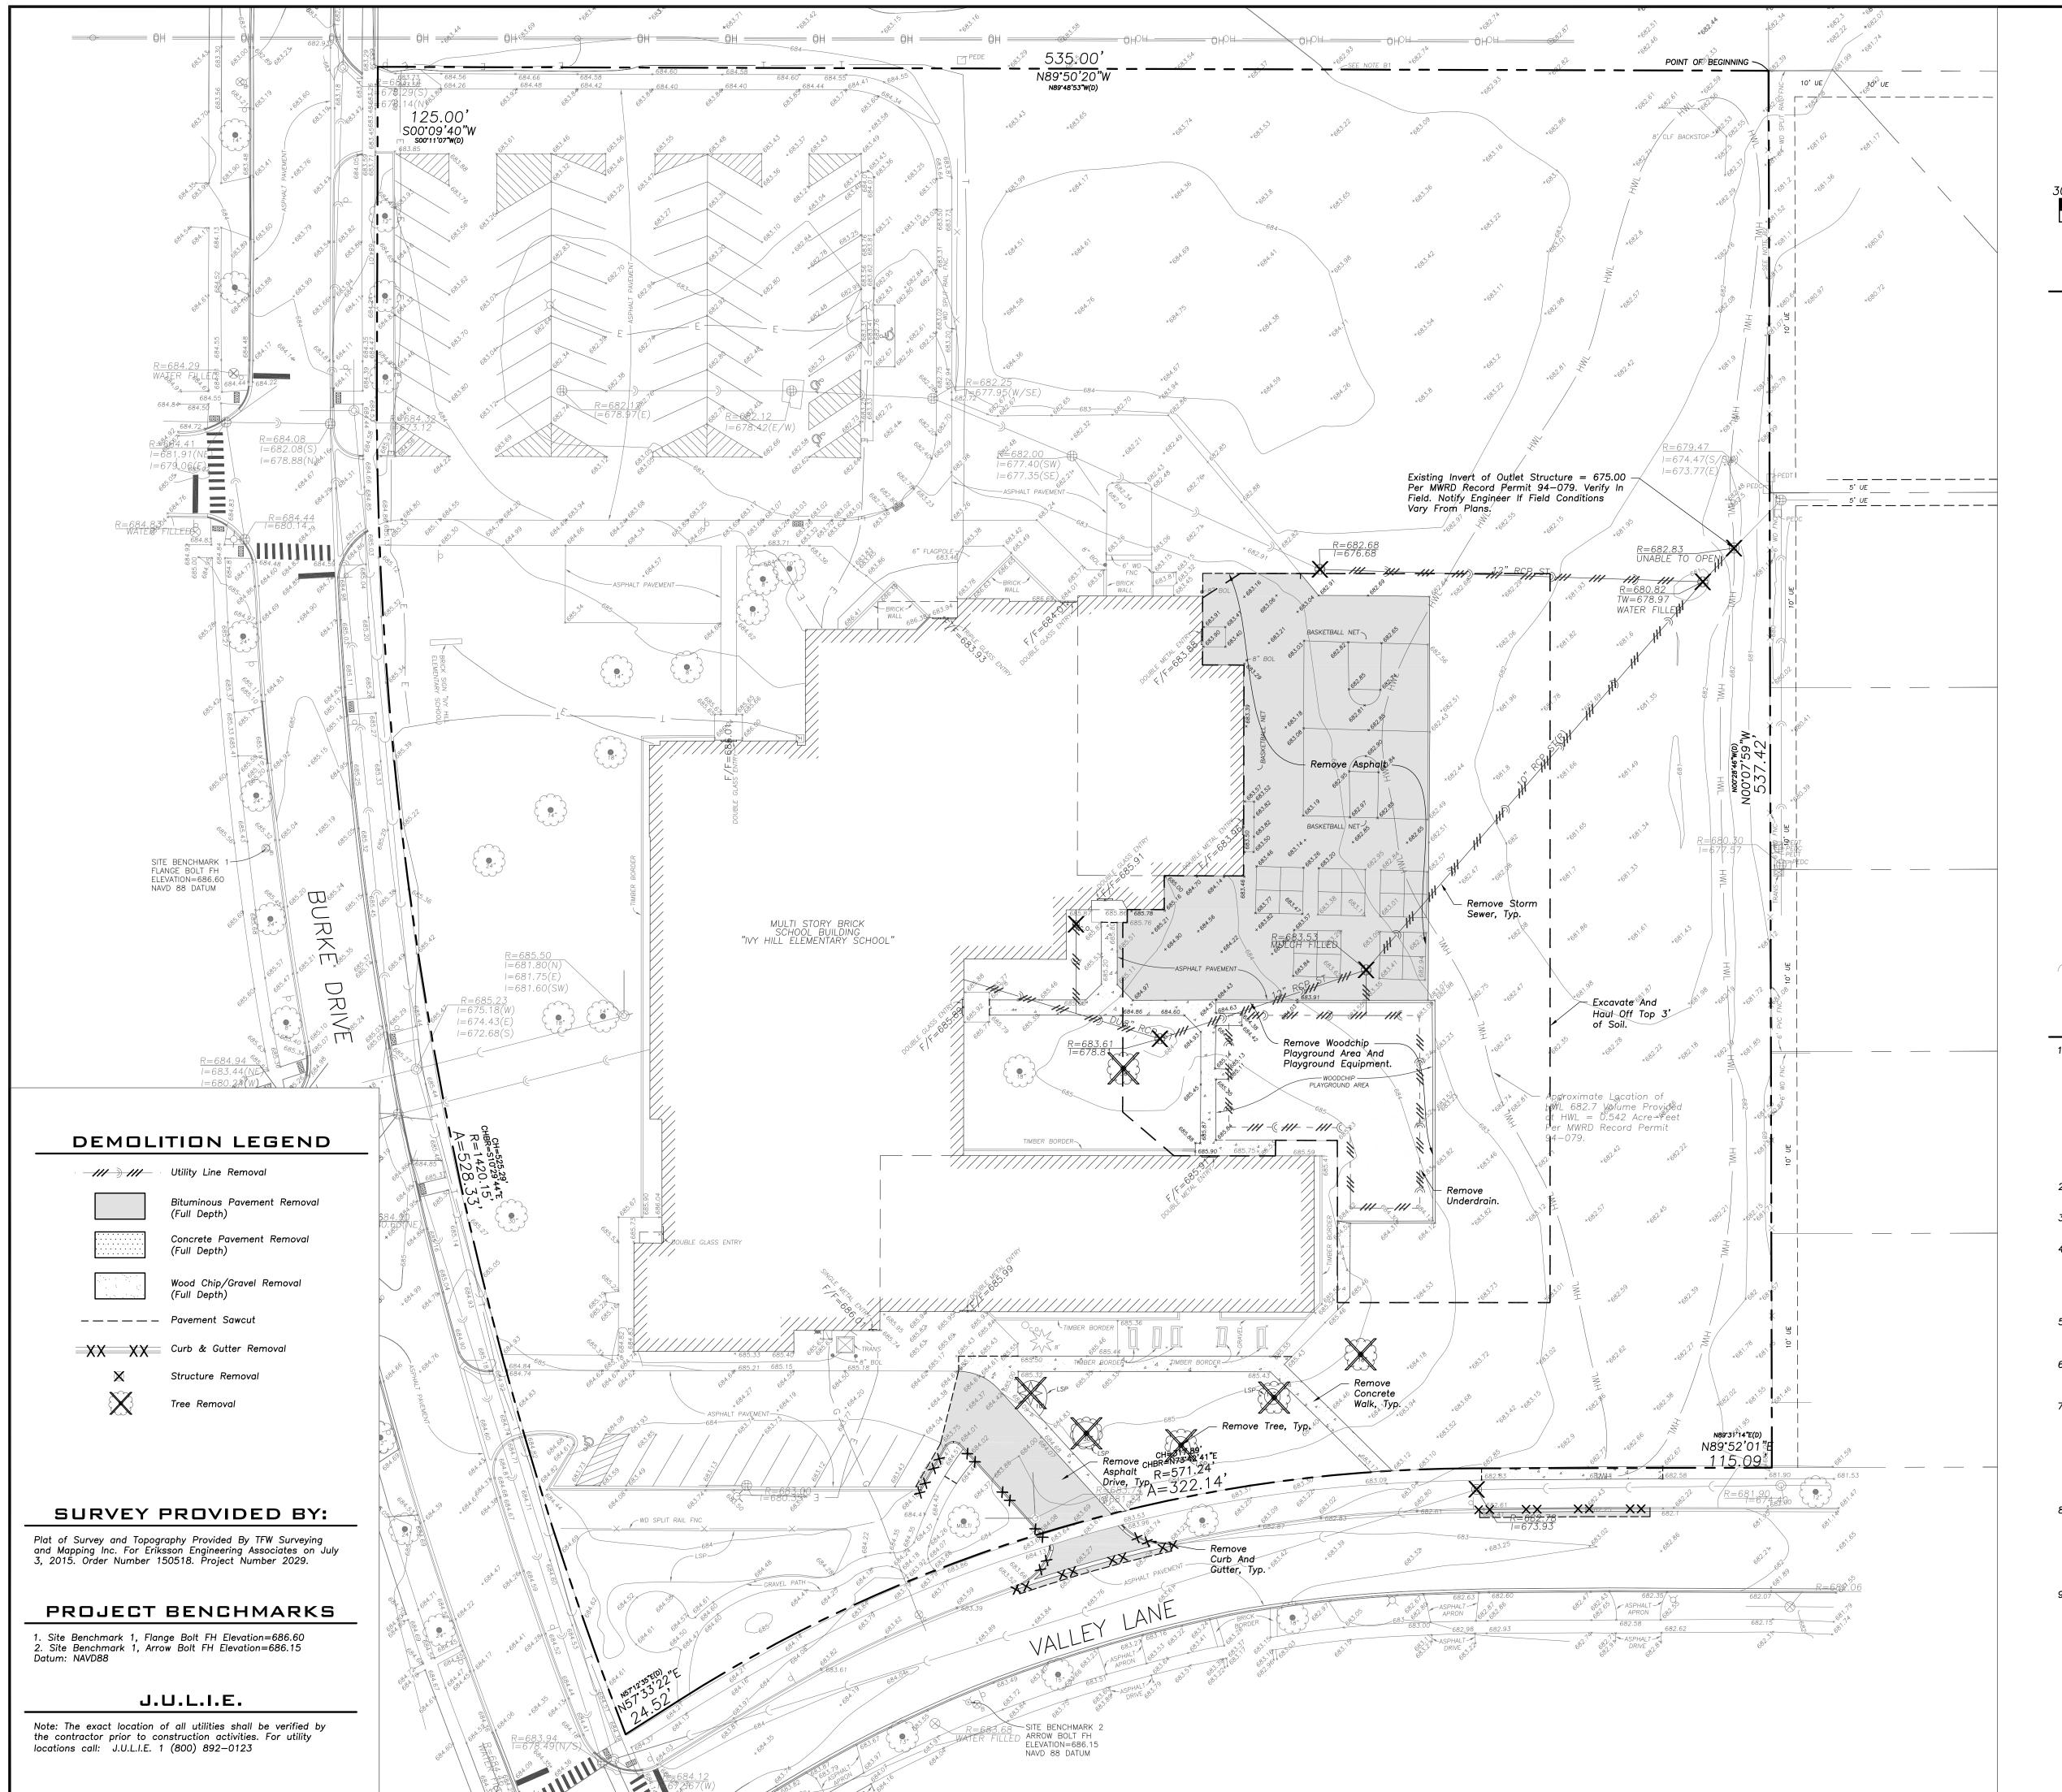
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**NOTES AND LEGENDS** 

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EXISTING		PROPOSED
	Manhole	•
$\bigoplus$	Catch Basin	
$\triangle$	Area Drain	<b>A</b>
O <sub>c.o.</sub>	Clean Out	$O_{c.o.}$
	Flared End Section	
	Storm Sewer	—— <b>)</b> ——
——)——	Sanitary Sewer	<del></del>
>	Combined Sewer	<b></b>
W	Water Main	——w—
——— G ———	Gas Line	———G———
——OH——	Overhead Wires	——ОН——
——Е—	Electrical Cable (Buried)	——Е——
——	Telephone Line	——т ——
Q	Fire Hydrant	A
$\otimes$	Valve Vault	
$\bigotimes_{B}$	Buffalo Box	$oldsymbol{\Theta}_{\!\scriptscriptstyleB}$
O <sub>DS</sub>	Downspout	● <sub>DS</sub>
$\otimes_{_{\mathbb{G}}}$	Gas Valve	
© <sub>CE</sub>	ComEd Manhole	
H	Hand Hole	
X	Light Pole	×
-0-	Utility Pole	<del>-</del> O-
⊠ <sub>T</sub>	Telephone Pedestal	
(O) <sub>T</sub>	Telephone Manhole	
d	Sign	•
××	Fence	xx
E	Accessible Parking Stall	Ġ.
	Curb & Gutter	
	Depressed Curb	
× C 782.50	Curb Elevation	C 782.50
x G 782.00	Gutter Elevation	G 782.00
x P 783.25	Pavement Elevation	<i>P 783.25</i>
× W 782.10	Sidewalk Elevation	<u>W 782.10</u>
x 784.0	Ground Elevation	<sub>x</sub> 784.0
× T/W 785.20	Top of Retaining Wall Elevation	T/W_785.20
	Swale	
	Contour Line	781
M & 3	Deciduous Tree	
- SW W	Coniferous Tree	
	Brushline	
	Tree Protection Fencing at Drip Line	·

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esign By:	Date:			
JC	06/06/15			
pproved By:	Project No.			
KC.				


Sheet Title:

SITE DEMOLITION PLAN


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EEA — P:\Josh\Arlington Heights School Dist 25\Drawings\Siteplan—lvy Hill 2015 Addition






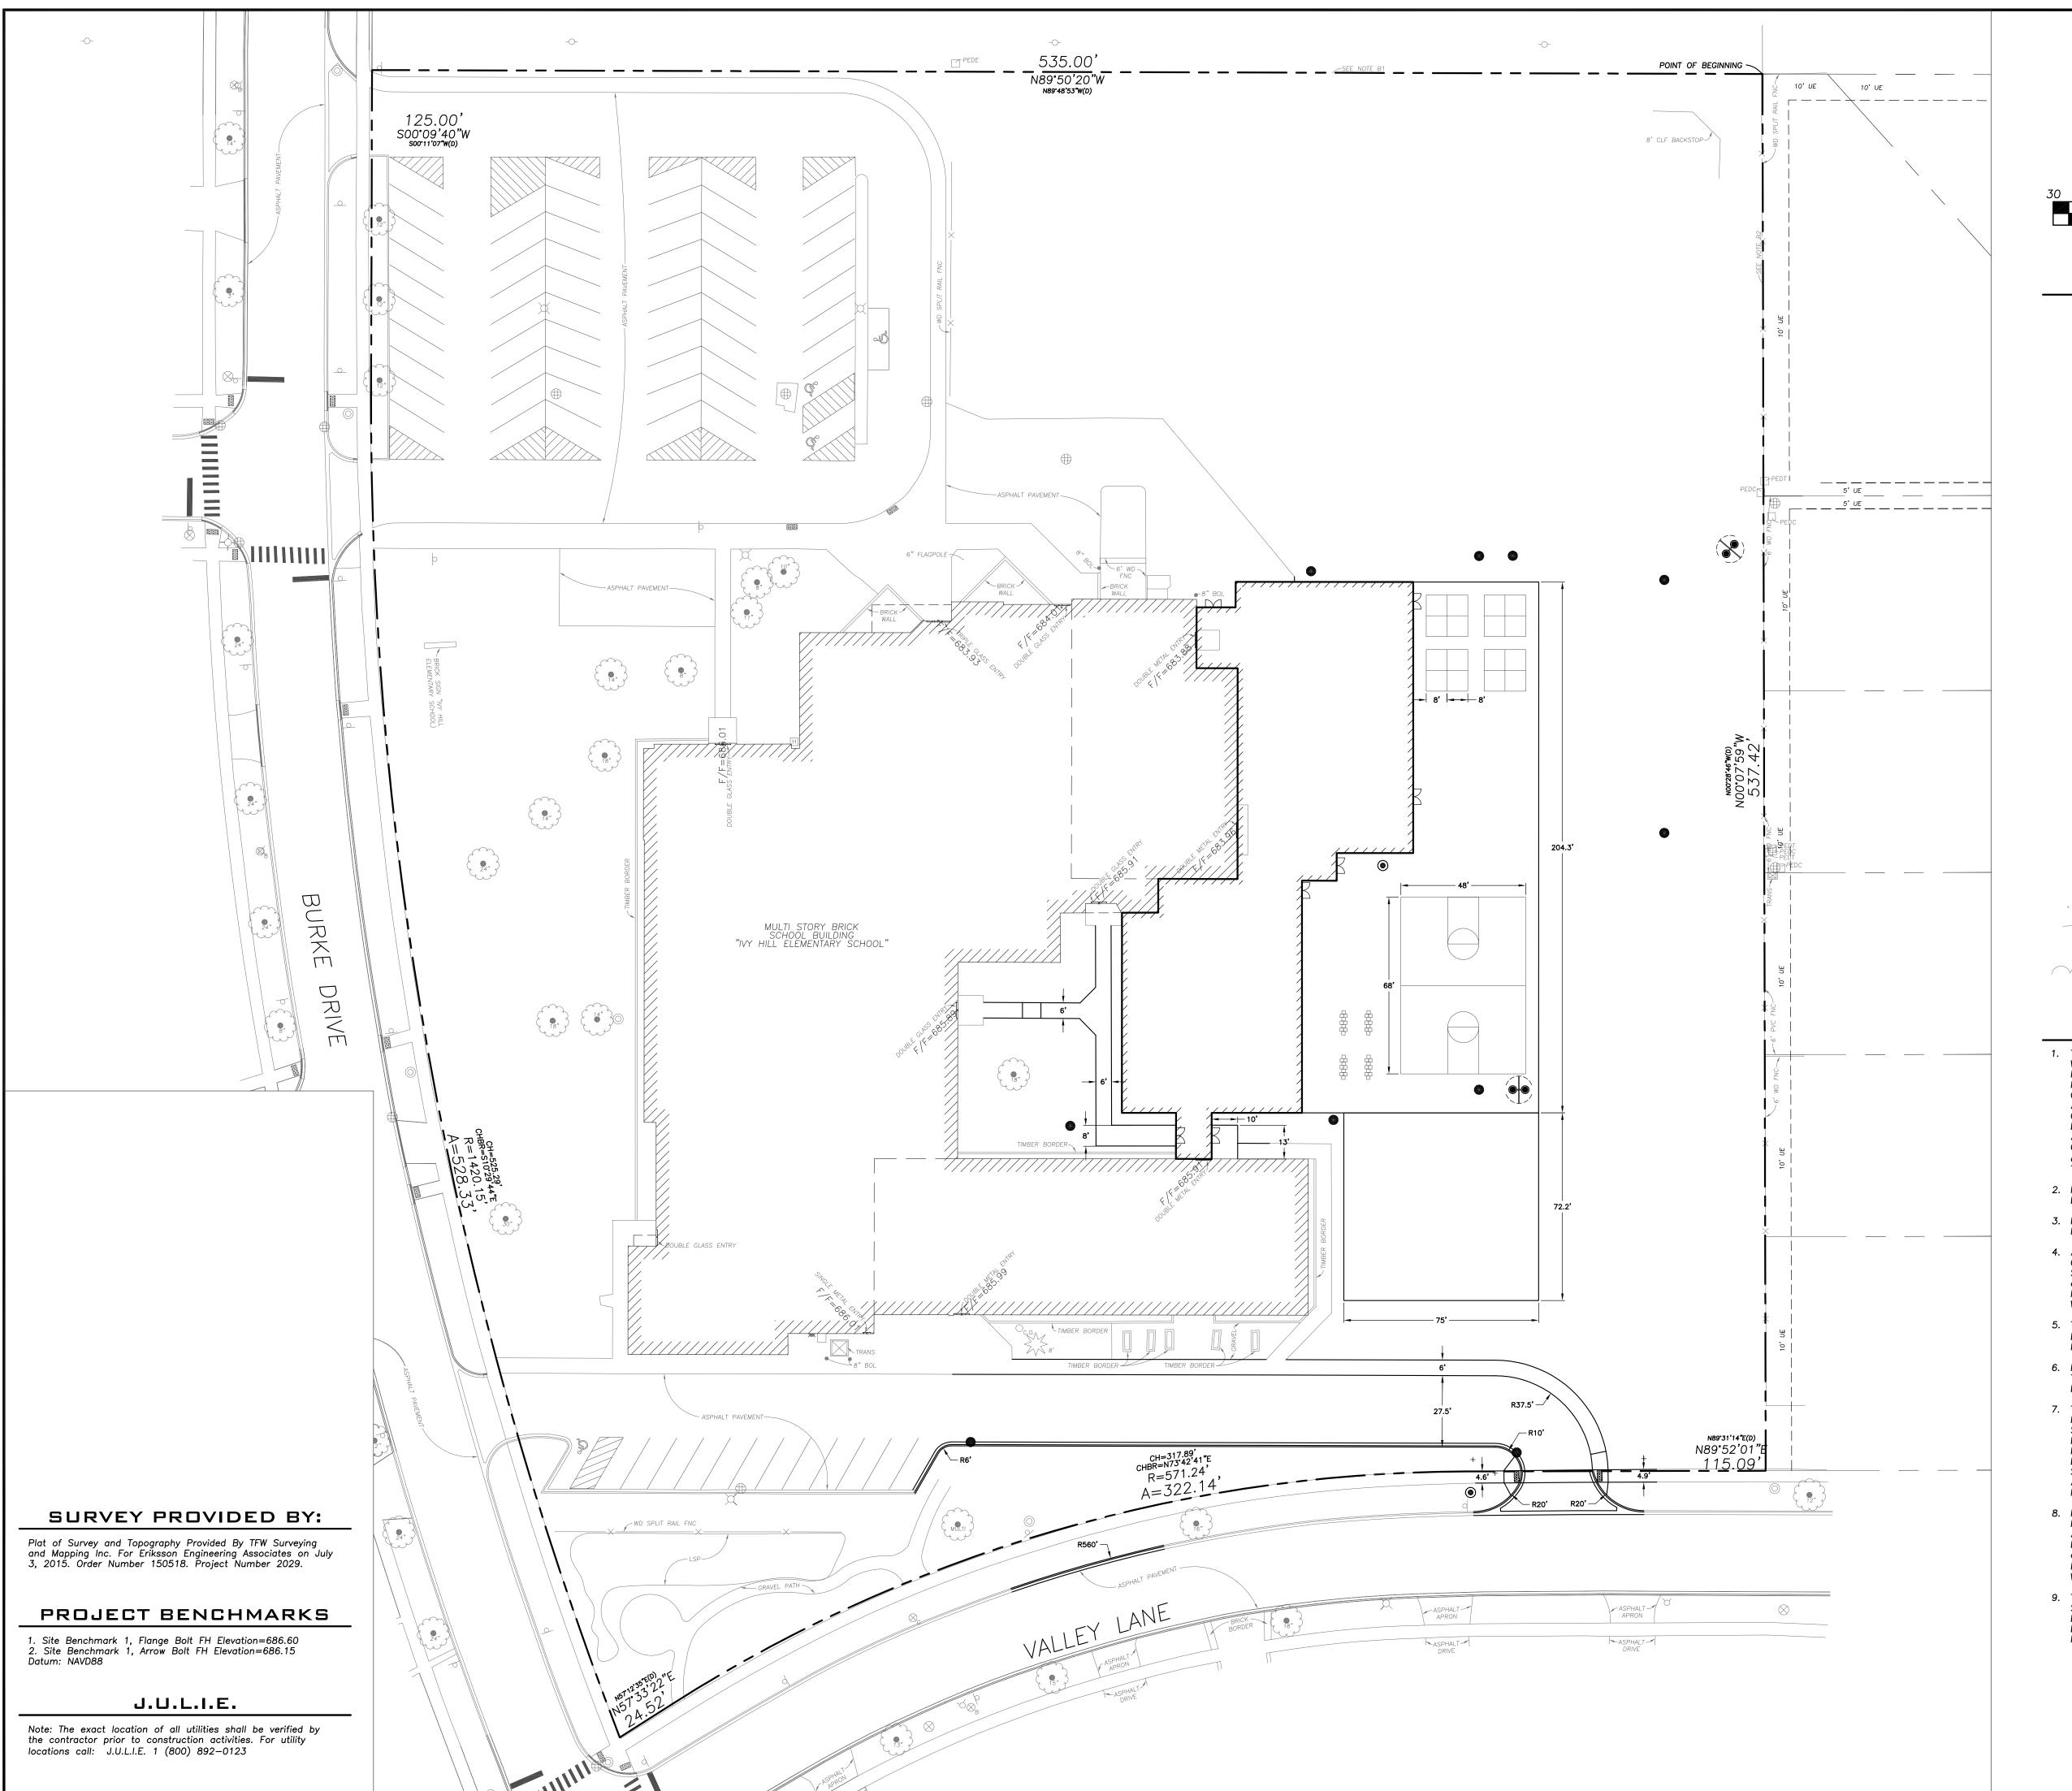

EXISTING		PROPOSED
	Manhole	•
	Catch Basin	
$\triangle$	Area Drain	<b>A</b>
O <sub>c.o.</sub>	Clean Out	$O_{c.o.}$
	Flared End Section	
——)——	Storm Sewer	—— <b>)</b> ——
——)—	Sanitary Sewer	<del></del>
>	Combined Sewer	<del></del>
———W——	Water Main	——w—
——— G ———	Gas Line	——-G——
——OH——	Overhead Wires	——ОН——
—— E ——	Electrical Cable (Buried)	——Е——
—— T ——	Telephone Line	—_T —
Q	Fire Hydrant	<b>A</b>
$\otimes$	Valve Vault	•
$\bigotimes_{B}$	Buffalo Box	$oldsymbol{\Theta}_{B}$
$O_{DS}$	Downspout	● <sub>DS</sub>
$\otimes_{_{\mathbb{G}}}$	Gas Valve	
CE	ComEd Manhole	
H	Hand Hole	
X	Light Pole	×
-0-	Utility Pole	-0-
$\boxtimes_{T}$	Telephone Pedestal	
○ <sub>T</sub>	Telephone Manhole	
d	Sign	•
××	Fence	××
	Accessible Parking Stall	<b>6</b>
	Curb & Gutter	
	Depressed Curb	
× C 782.50	Curb Elevation	C 782.50
x G 782.00	Gutter Elevation	G 782.00
x P 783.25	Pavement Elevation	<i>P 783.25</i>
× W 782.10	Sidewalk Elevation	<u>W 782.10</u>
x 784.0	Ground Elevation	<sub>x</sub> 784.0
× T/W 785.20	Top of Retaining Wall Elevation	<i>T/W_785.20</i>
• • • • • • • • • • • • • • • • • •	Swale	
	Contour Line	
W E • 3	Deciduous Tree	
IN CO	Coniferous Tree	
	Brushline	
	Tree Protection Fencing at Drip Line	·
	, snowing at Drip Line	
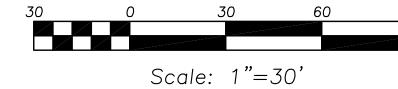
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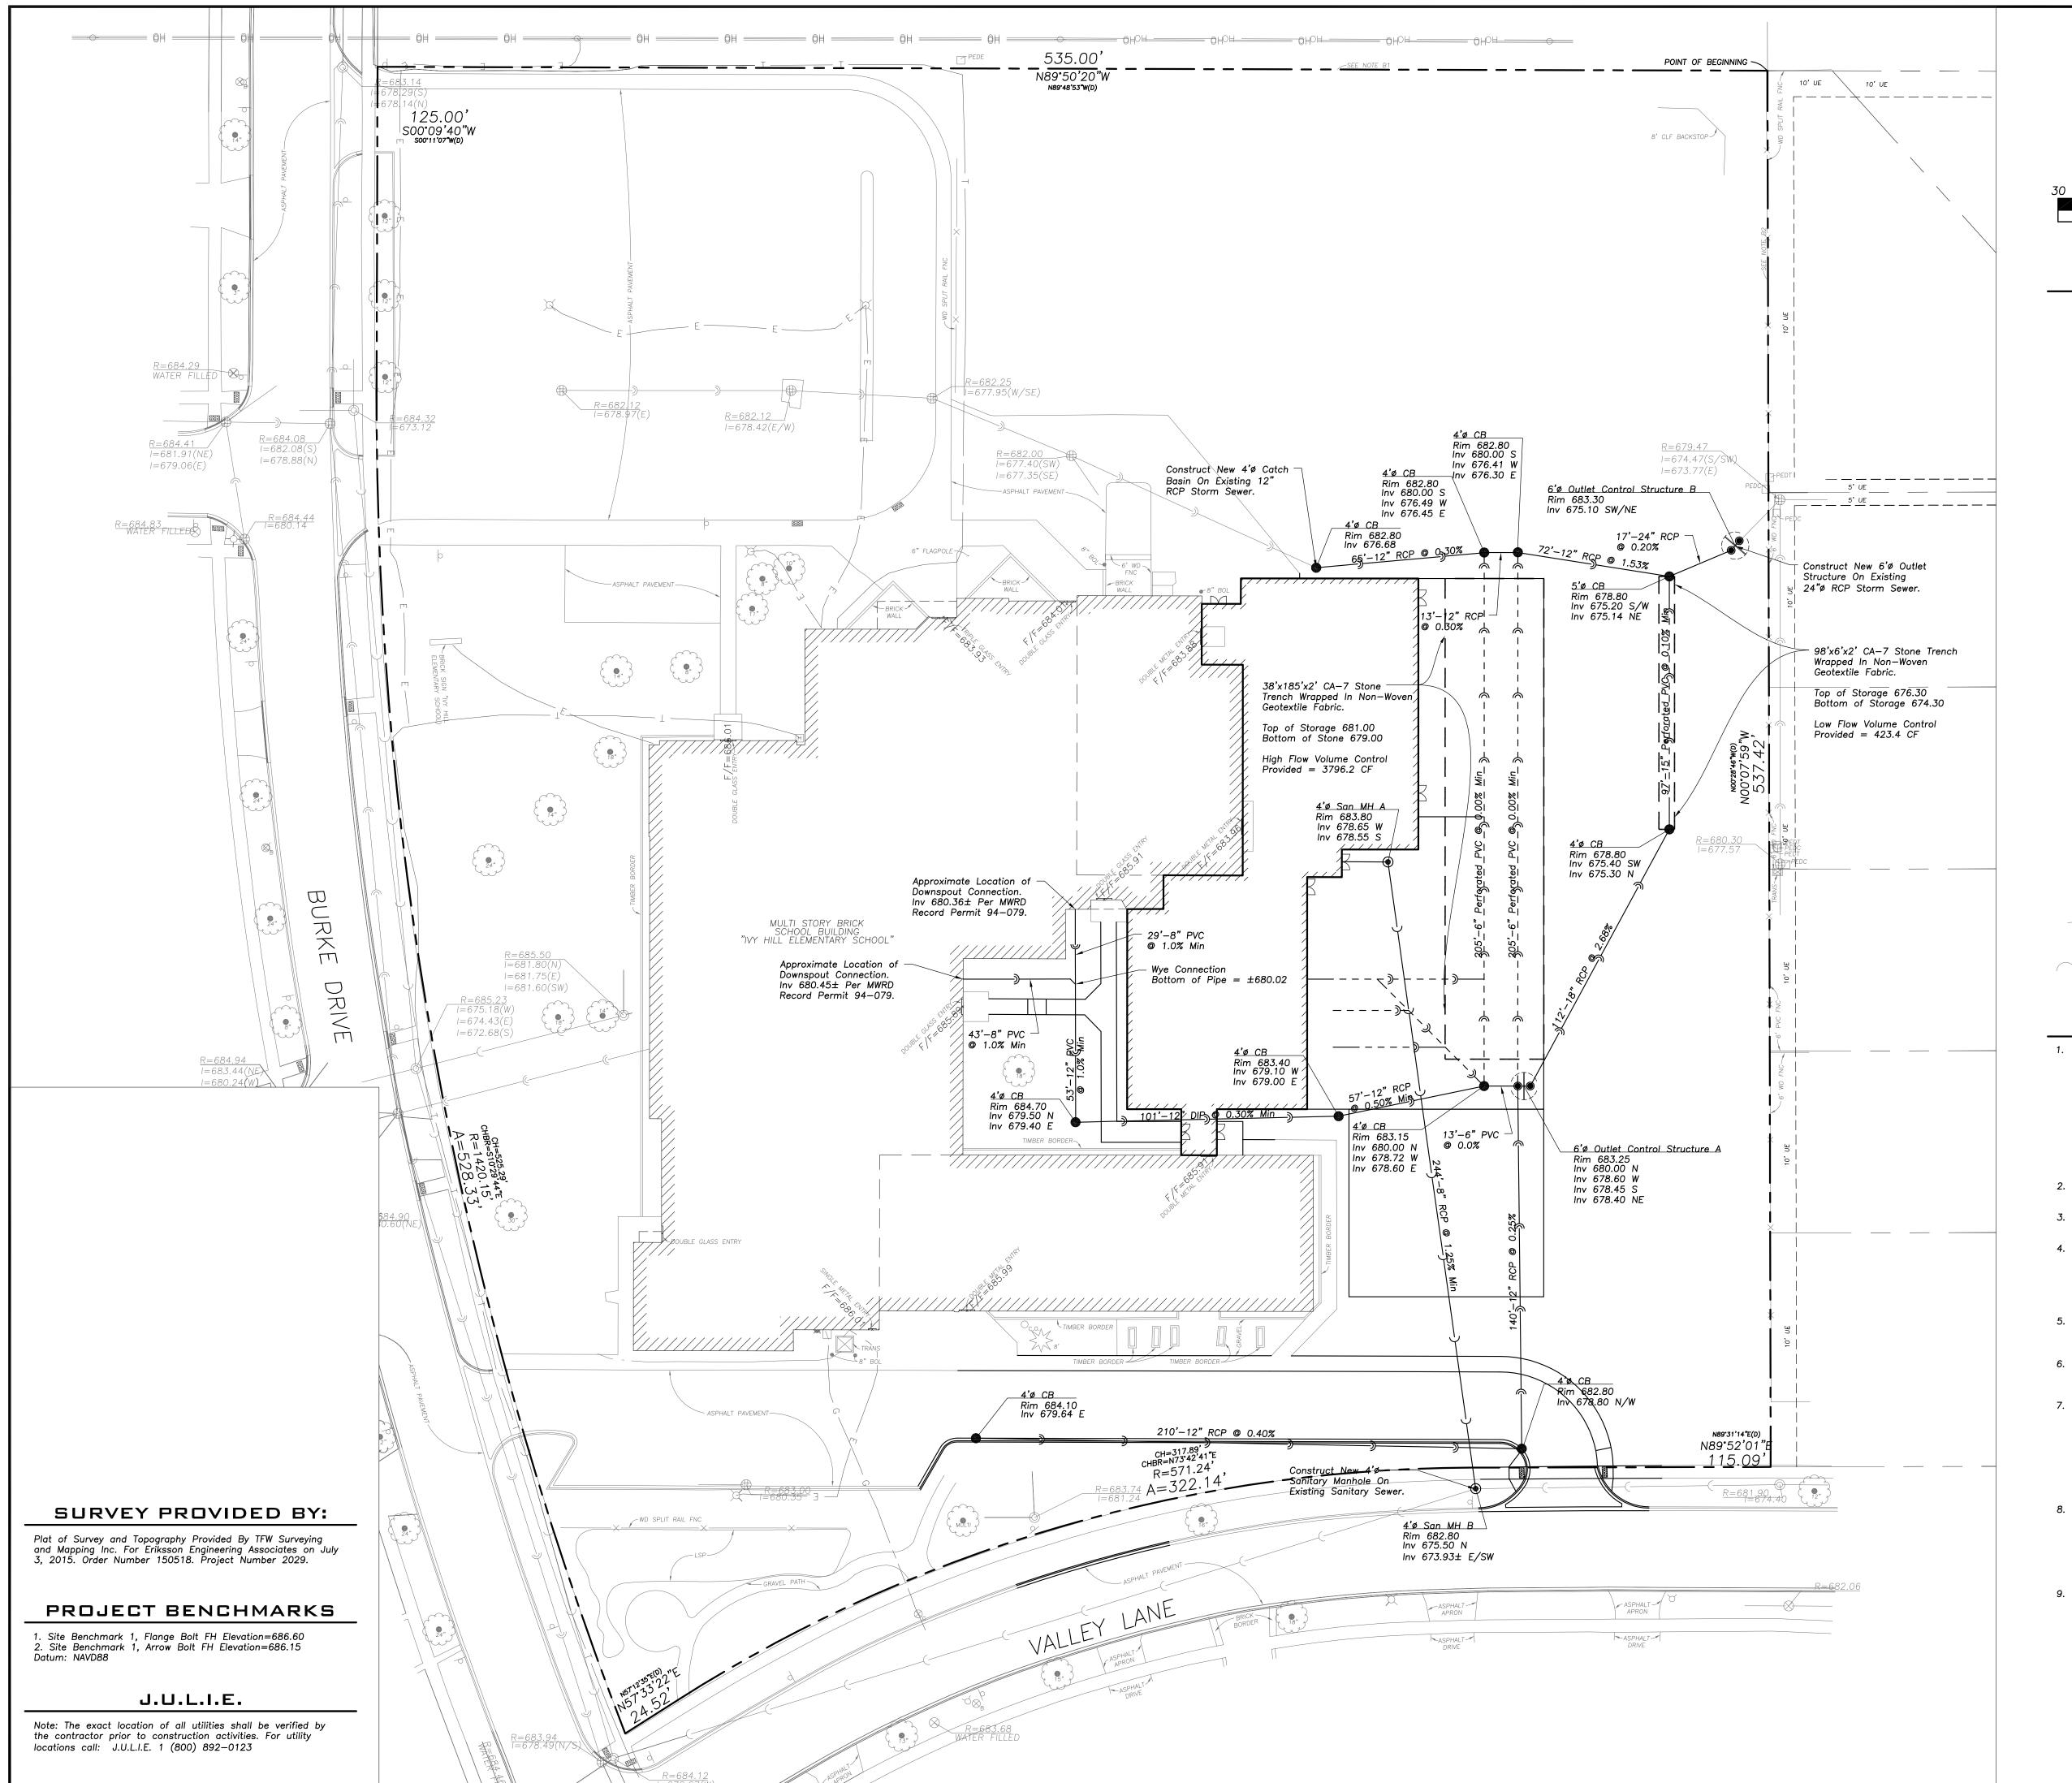
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Approved By:	Project No.
KC	

Sheet Title:

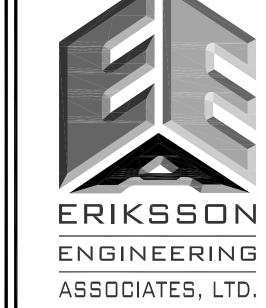SITE GEOMETRY PLAN

Sheet No:

C-2.1







	LEGEND	
EXISTING		PROPOSED
$\bigcirc$	Manhole	
	Catch Basin	
$\triangle$	Area Drain	<b>A</b>
O <sub>c.o.</sub>	Clean Out	O <sub>c.o.</sub>
	Flared End Section	
——)—	Storm Sewer	—— <u>»</u> —
——)——	Sanitary Sewer	<del></del>
	Combined Sewer	<b>——</b>
W	Water Main	——w—
——— G ———	Gas Line	——-G——
OH	Overhead Wires	——он——
——E——	Electrical Cable (Buried)	——Е——
—— T ——	Telephone Line	—т—
Q	Fire Hydrant	<b>A</b>
$\otimes$	Valve Vault	•
$\otimes_{B}$	Buffalo Box	$oldsymbol{\Theta}_{\!B}$
O <sub>DS</sub>	Downspout	● <sub>DS</sub>
$\otimes_{_{\mathbb{G}}}$	Gas Valve	
CE	ComEd Manhole	
Н	Hand Hole	
X	Light Pole	×
-0-	Utility Pole	-0-
⊠ <sub>T</sub>	Telephone Pedestal	
◎ <sub>T</sub>	Telephone Manhole	
d	Sign	•
××	Fence	××
<u> </u>	Accessible Parking Stall	Ġ.
	Curb & Gutter	
	Depressed Curb	
× C 782.50	Curb Elevation	C 782.50
x G 782.00	Gutter Elevation	G 782.00
x P 783.25	Pavement Elevation	P 783.25
× W 782.10	Sidewalk Elevation	<i>W 782.10</i>
x 784.0	Ground Elevation	<sub>x</sub> 784.0
× T/W 785.20	Top of Retaining Wall Elevation	<i>T/W_785.20</i>
• • • • • • • • • • • • • • • • • •	Swale	
	Contour Line	781
W ( 3	Deciduous Tree	
	Coniferous Tree	
	Brushline	
	Tree Protection Fencing at Drip Line	·

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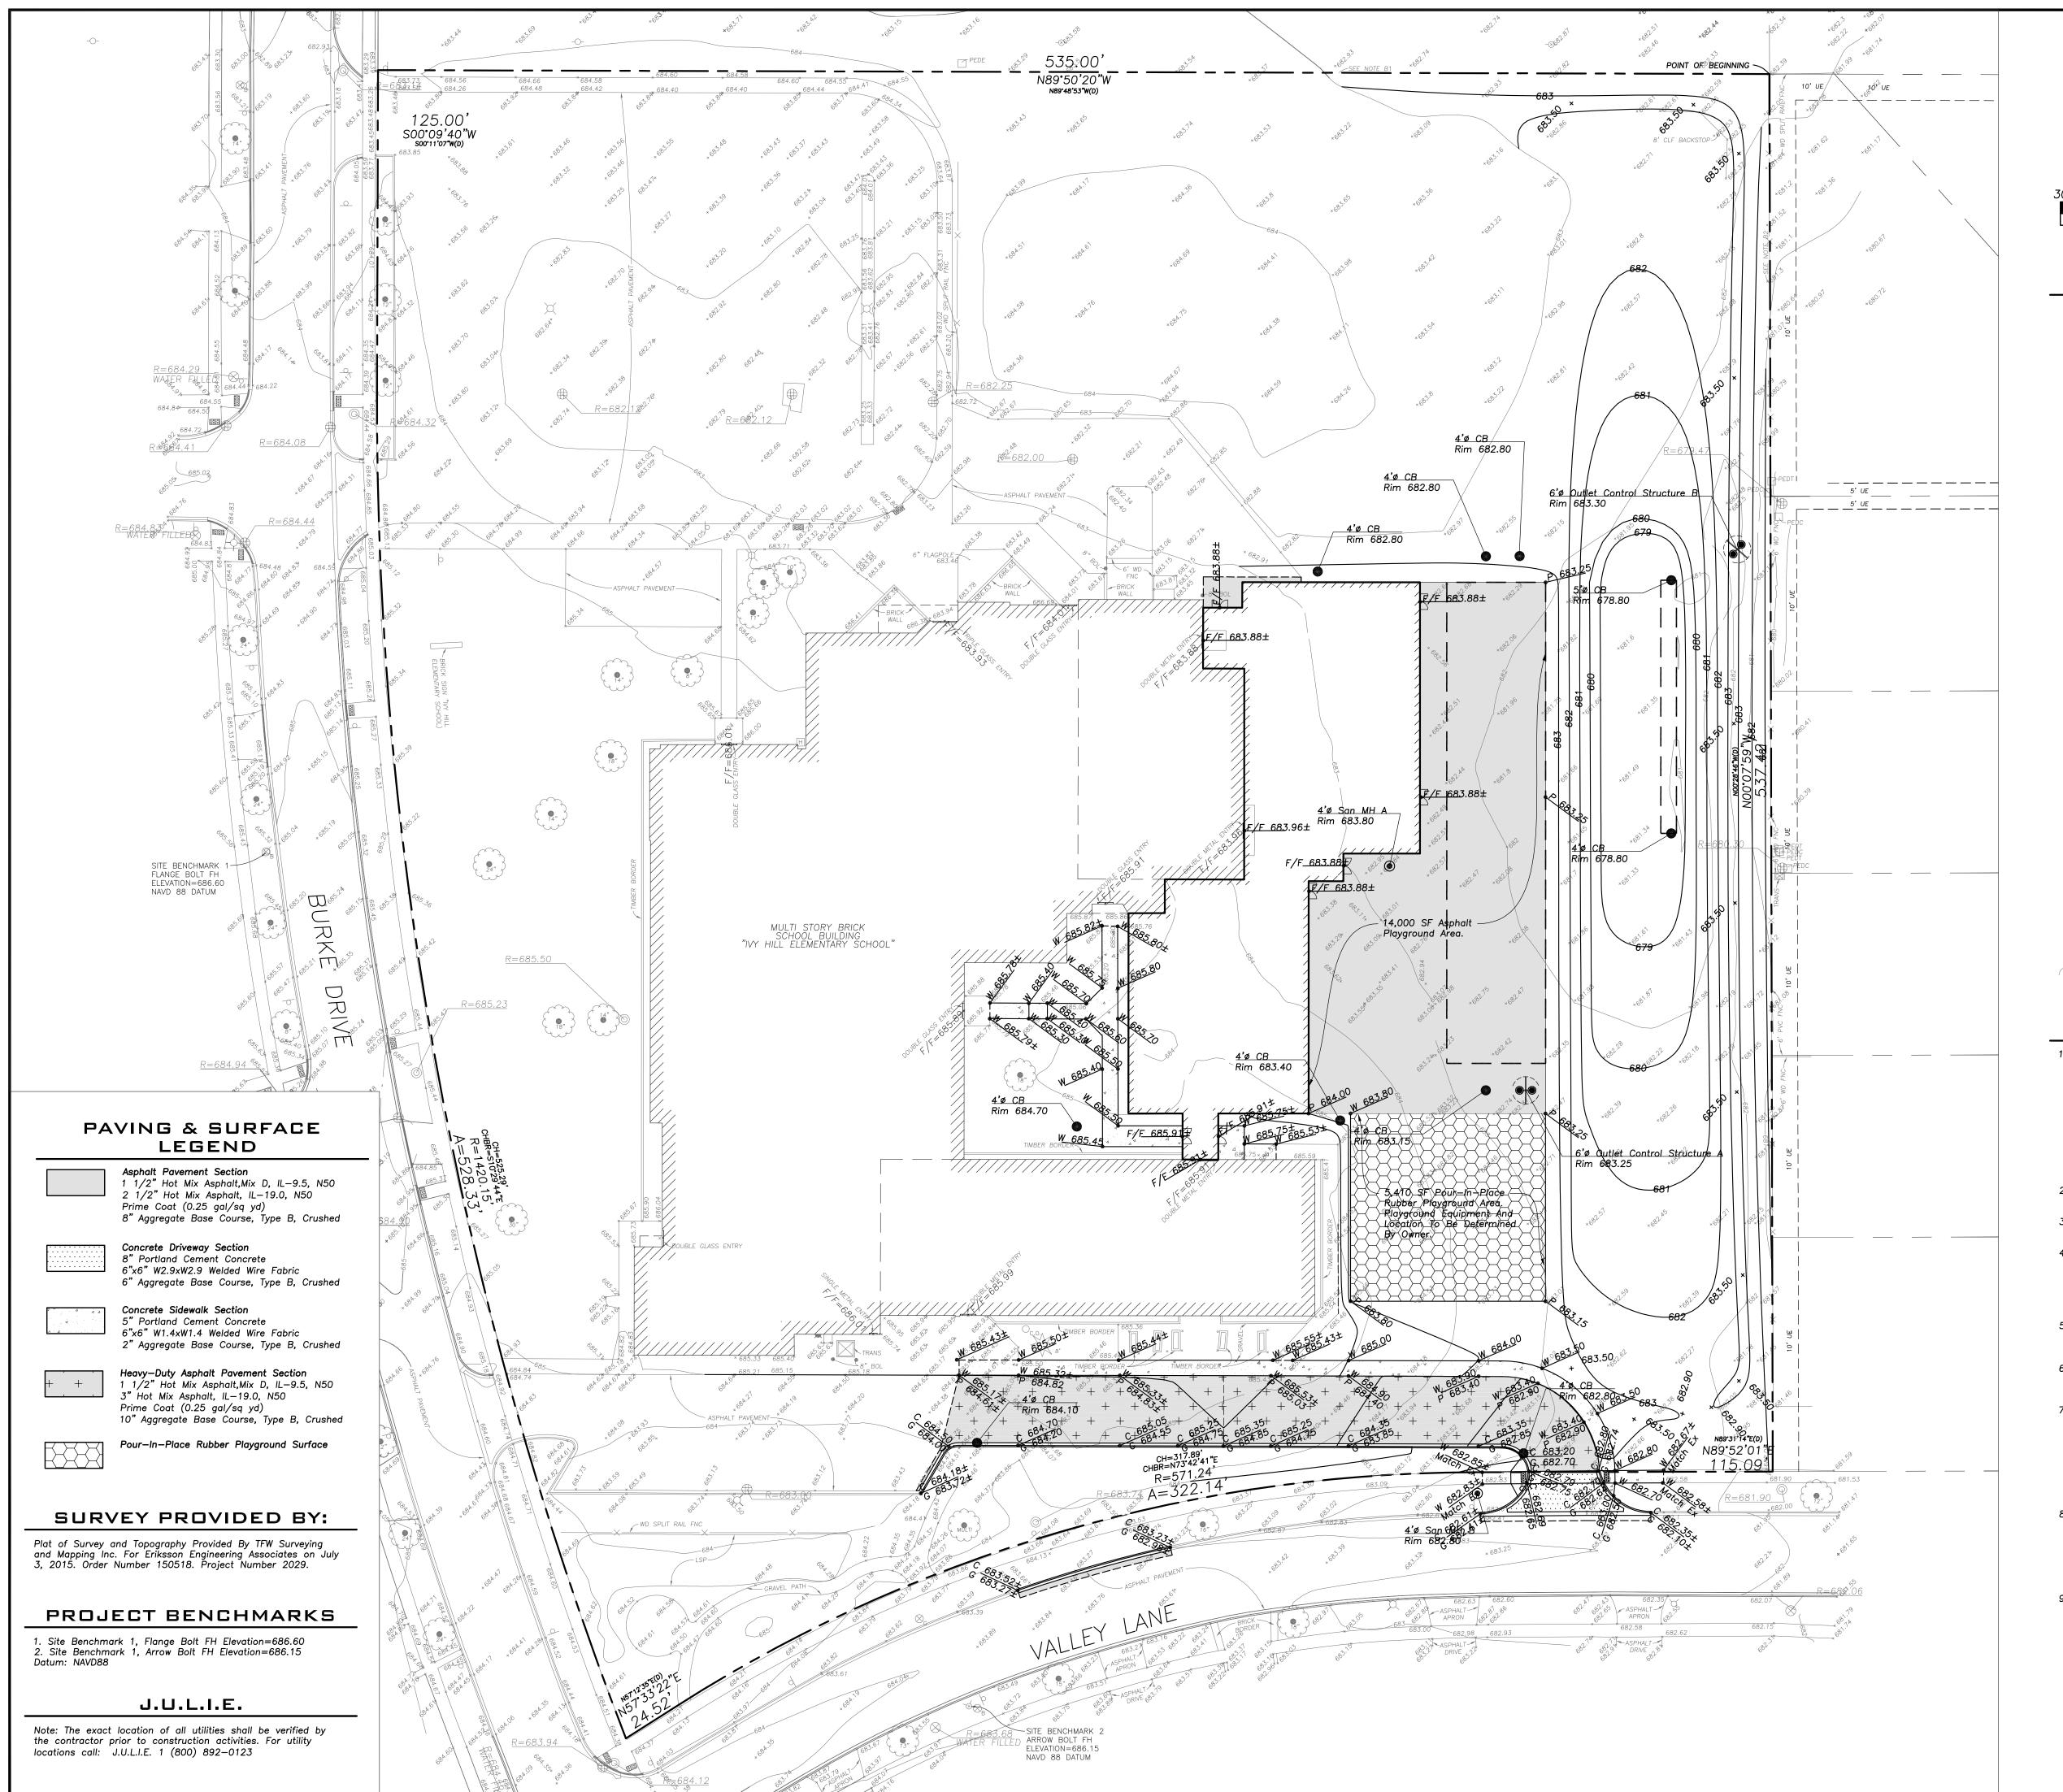
Sheet Title:

SITE UTILITY PLAN

Sheet No:

C-3.1

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EXISTING		PROPOSED
	Manhole	
	Catch Basin	
$\triangle$	Area Drain	<b>A</b>
$\bigcirc_{\text{c.o.}}$	Clean Out	$O_{c.o.}$
	Flared End Section	
——)——	Storm Sewer	<del></del>
——)——	Sanitary Sewer	—)—
>	Combined Sewer	<del></del>
————W———	Water Main	w
——— G ———	Gas Line	——-G——
——OH——	Overhead Wires	——ОН——
——Е——	Electrical Cable (Buried)	——Е——
—— T ——	Telephone Line	—т—
Q	Fire Hydrant	<b>A</b>
$\otimes$	Valve Vault	•
$\bigotimes_{B}$	Buffalo Box	$lackbox{lack}_{lack}$
O <sub>DS</sub>	Downspout	● <sub>DS</sub>
$\otimes_{_{\mathbb{G}}}$	Gas Valve	
© <sub>CE</sub>	ComEd Manhole	
Н	Hand Hole	
X	Light Pole	×
-0-	Utility Pole	-0-
$\bowtie_{T}$	Telephone Pedestal	
⊚ <sub>T</sub>	Telephone Manhole	
d	Sign	•
××	Fence	××
E.	Accessible Parking Stall	Ġ.
	Curb & Gutter	
	Depressed Curb	
× C 782.50	Curb Elevation	C 782.50
x G 782.00	Gutter Elevation	G 782.00
x P 783.25	Pavement Elevation	P 783.25
× W 782.10	Sidewalk Elevation	<i>₩ 782.10</i>
x 784.0	Ground Elevation	<sub>x</sub> 784.0
× T/W 785.20	Top of Retaining Wall Elevation	<i>T/W_785.20</i>
• • • • • • • • • • • • • • • • • •	Swale	
	Contour Line	781
W ( • 3	Deciduous Tree	
My ww	Coniferous Tree	
	Brushline	

# Tree Protection Fencing at Drip Line GENERAL NOTES

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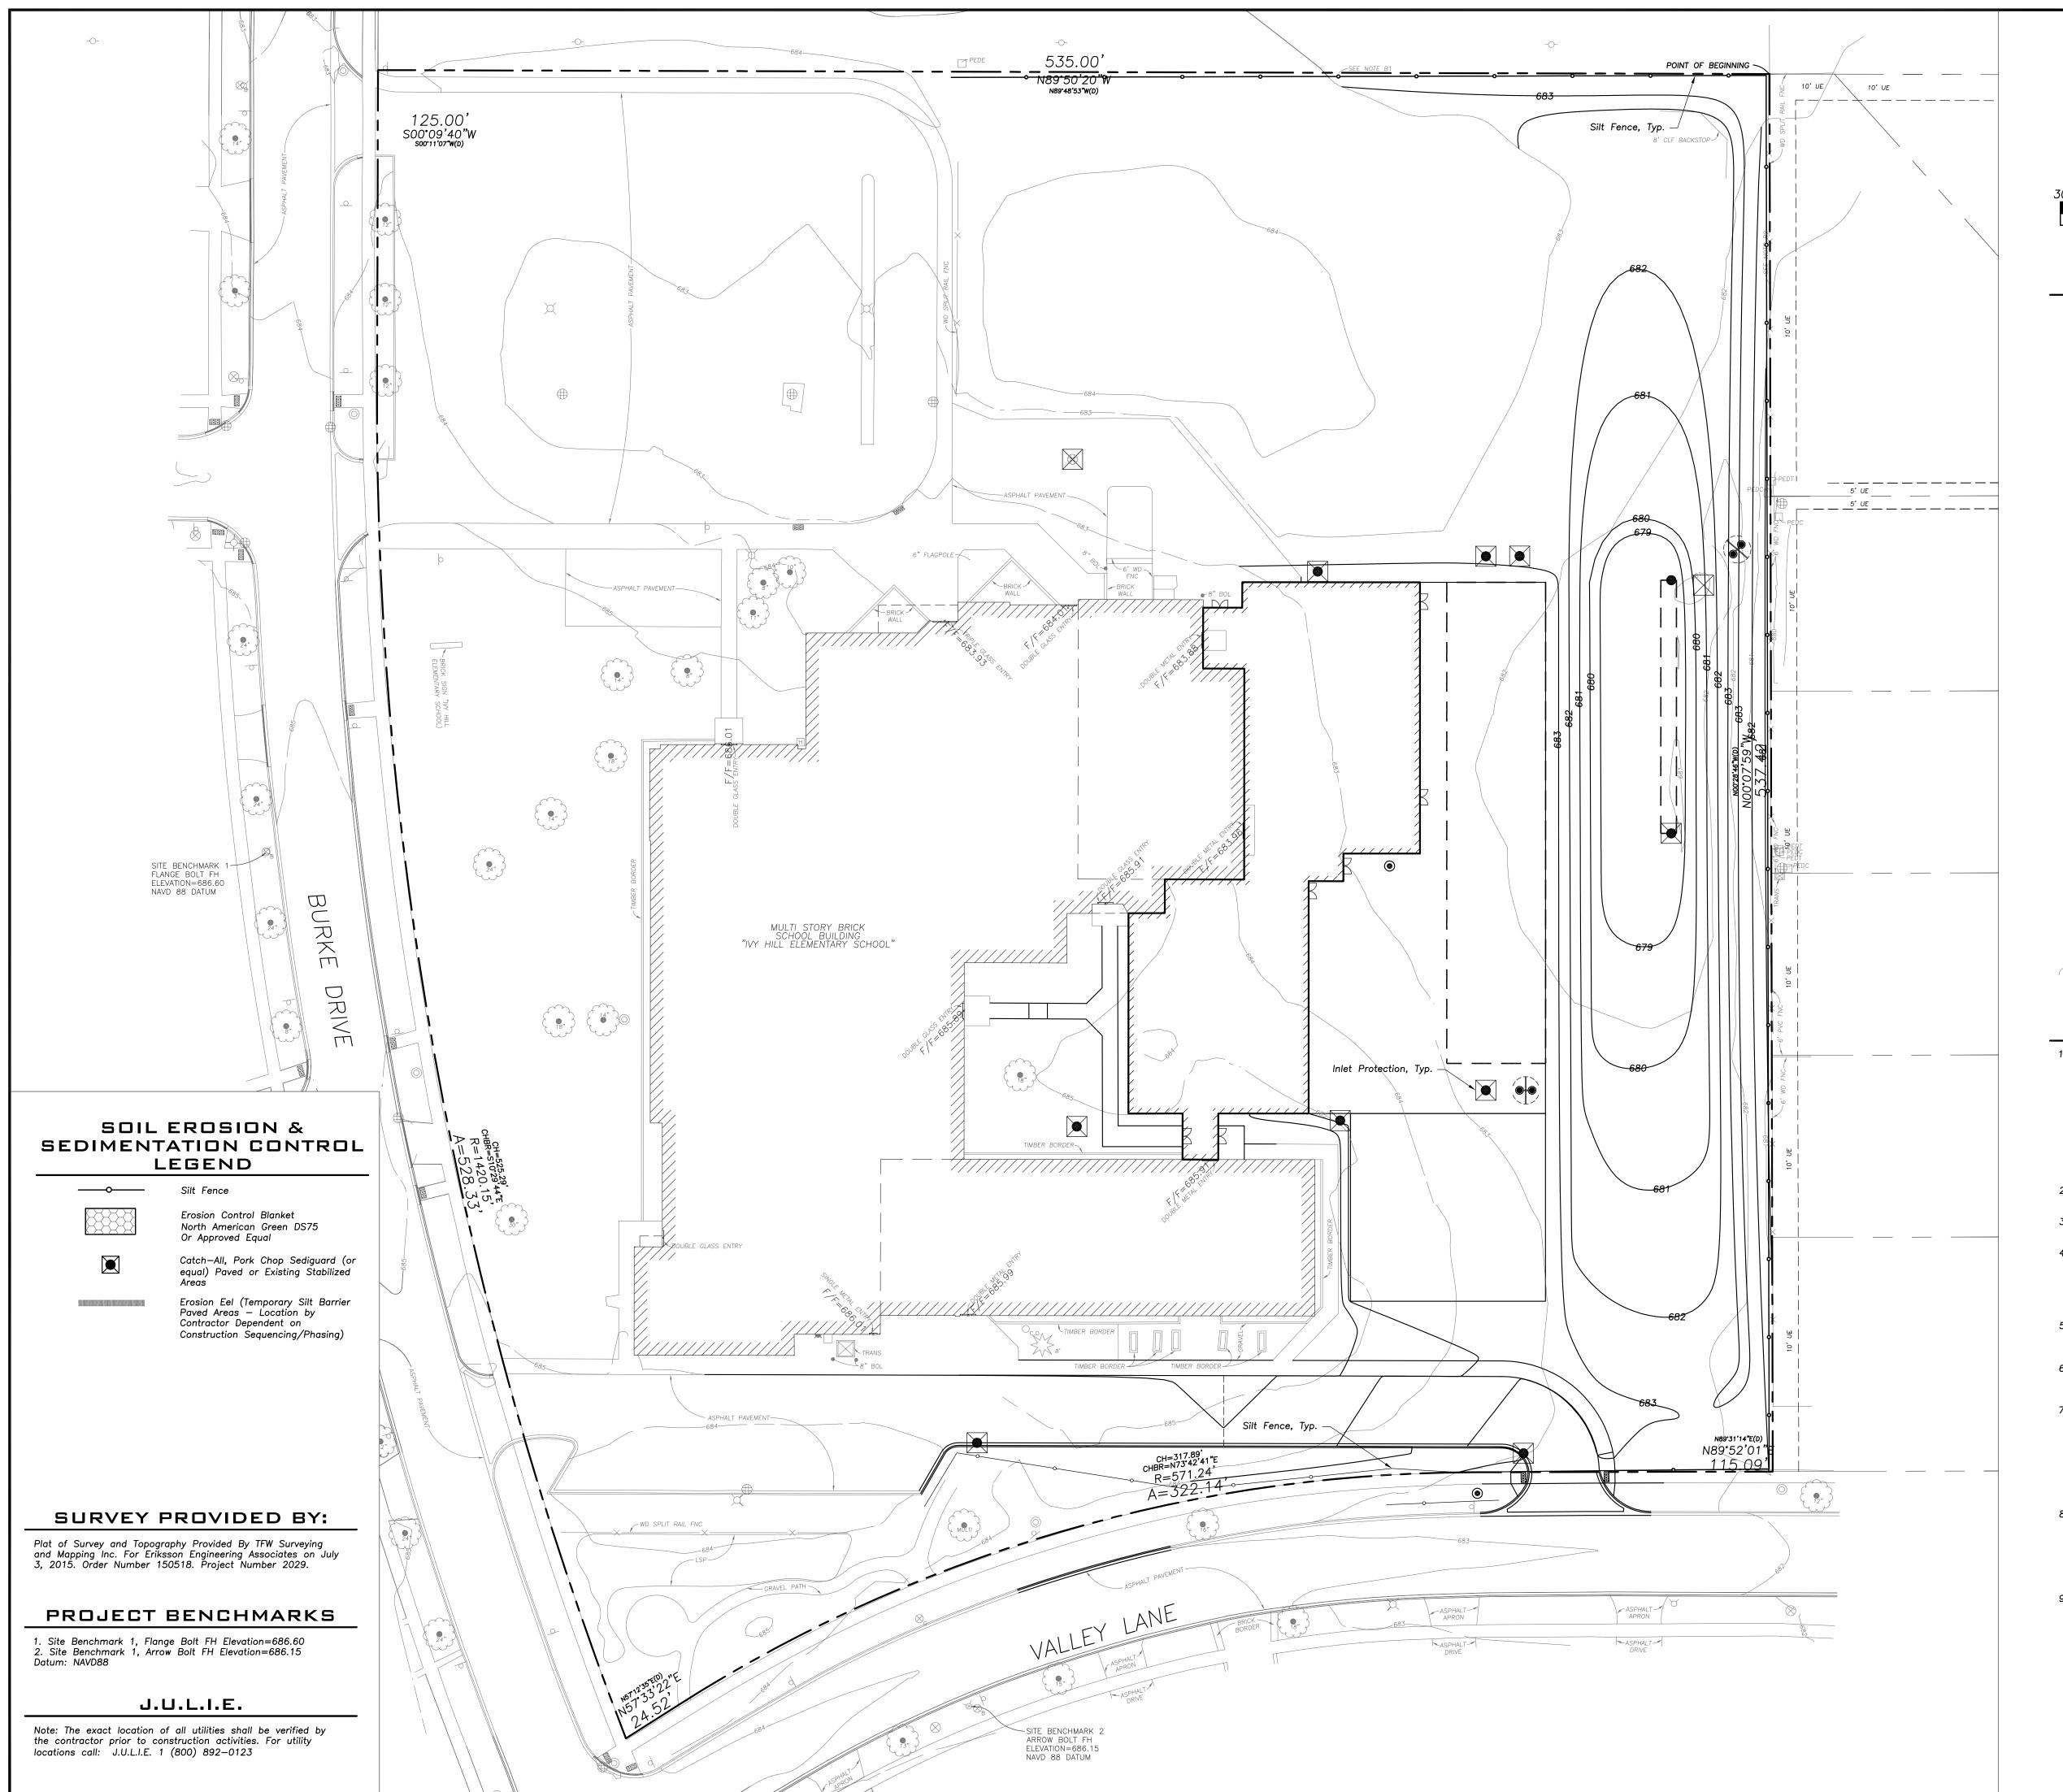
| Date: | O6/06/15 |
| Approved By: | Project No. | KC

Sheet Title:


GRADING AND PAVING PLAN-OPTION 1

Sheet No:

C-4.1





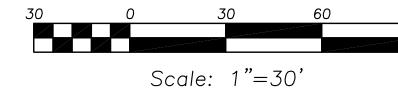

EXISTING		PROPOSED
EXISTING	Manhala	_
<b>⊕</b>	Manhole Catch Basin	<ul><li></li></ul>
^	Area Drain	<b>*</b>
		•
O <sub>c.o.</sub>	Clean Out	O <sub>c.o.</sub>
	Flared End Section	
	Storm Sewer	
	Sanitary Sewer	<del></del>
	Combined Sewer	
———W——	Water Main	——w—
——- G ——	Gas Line	——-G——
——OH——	Overhead Wires	——он——
—— E ——	Electrical Cable (Buried)	——Е——
——	Telephone Line	—_т—
Q	Fire Hydrant	<b>A</b>
$\otimes$	Valve Vault	•
$\otimes_{_{B}}$	Buffalo Box	$oldsymbol{\Theta}_{B}$
$\circ_{ t DS}$	Downspout	● <sub>DS</sub>
$\bigotimes_{G}$	Gas Valve	
O <sub>CE</sub>	ComEd Manhole	
Н	Hand Hole	
X	Light Pole	×
-0-	Utility Pole	-0-
⊠ <sub>T</sub>	Telephone Pedestal	
$\bigcirc$ $\top$	Telephone Manhole	
d	Sign	
××	Fence	××
E	Accessible	
	Parking Stall	
	Curb & Gutter	
	Depressed Curb	
× C 782.50 × G 782.00	Curb Elevation	<u>C 782.50</u> G 782.00
	Gutter Elevation	
x P 783.25	Pavement Elevation	P 783.25
× W 782.10	Sidewalk Elevation	<u>W 782.10</u>
× 784.0 × T/W 785.20	Ground Elevation	<sub>x</sub> 784.0 T/W_785.20
^ 1/W 765.20	Top of Retaining Wall Elevation	17W 783.20
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M ( )	Deciduous Tree	
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Date:

### Date:
### O6/06/15


Approved By:
### Project No.
### KC

SOIL EROSION &
SEDIMENT
CONTROL PLAN

Sheet No:

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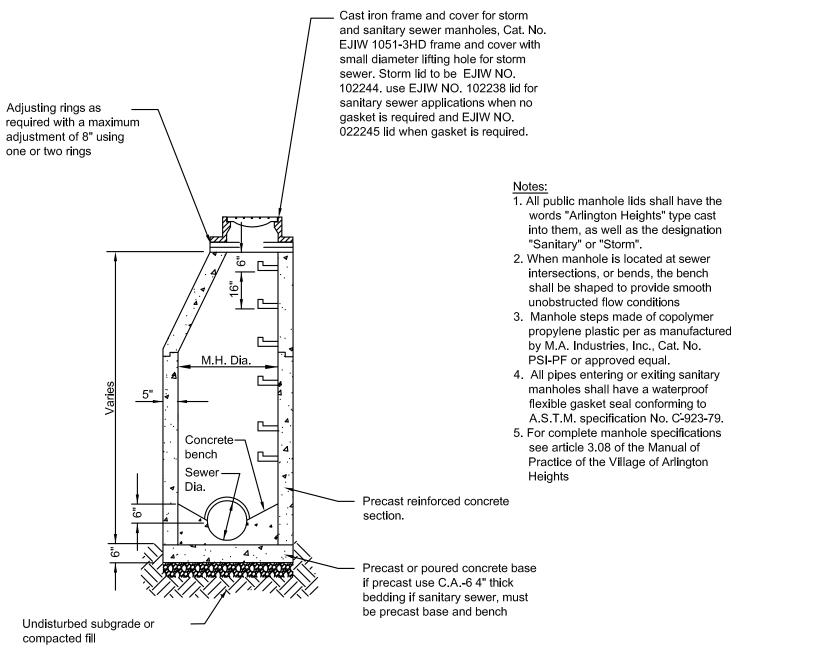
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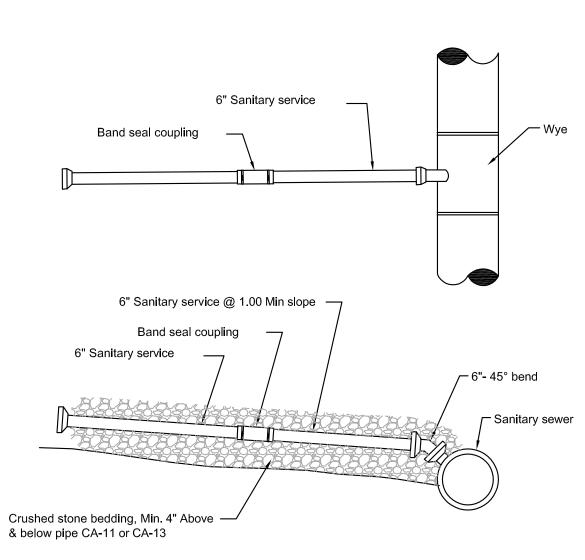
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**NOTES AND** LEGENDS

C-6.1

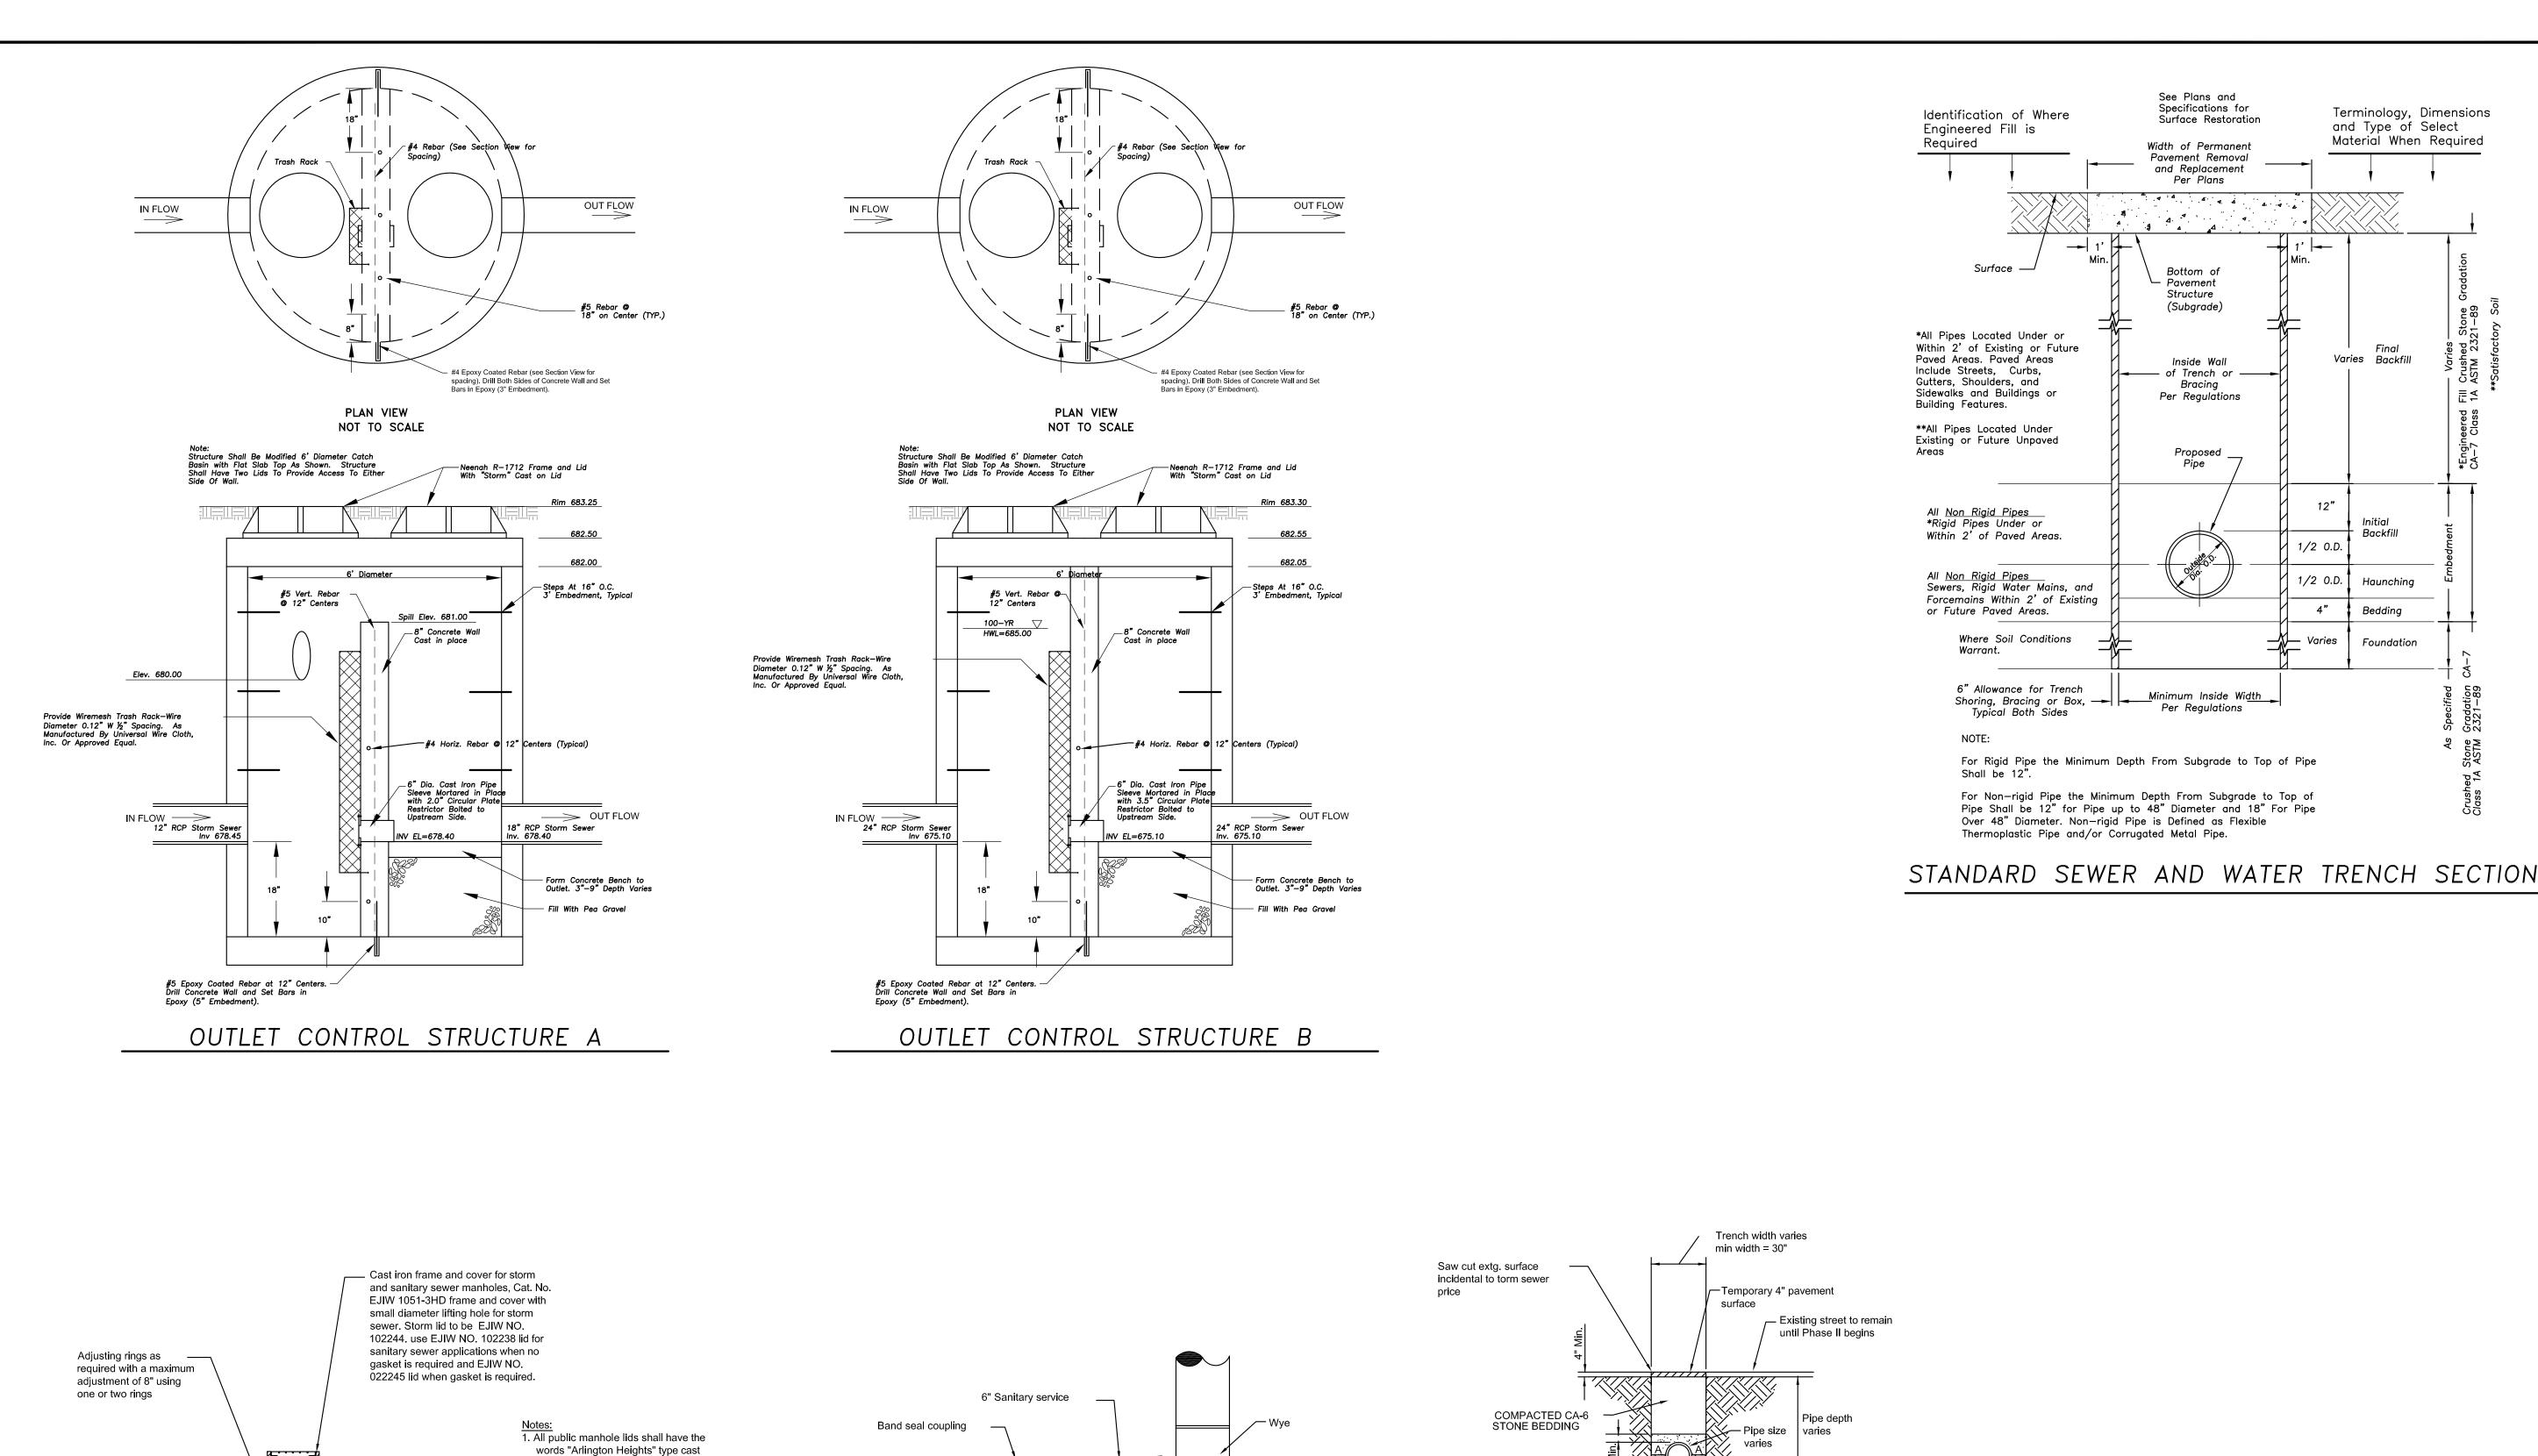

TYPE A - MANHOLE





SANITARY SEWER TRENCH DETAIL

A: Minimum distance of

pipe to trench wall

4" (MIN) CA-11 -STONE BEDDING

Notes:
When preparing for street subgrade

removal of compacted stone subgrade

No separate payment will be made for

fittings required for diverting sanitary

sewer lines around proposed sewers. this cost of fittings will be incidental

to the cost of the storm sewer pipe.

Cost of stone bedding material as

shown shall be incidential to sewer pay

shall be included with earth ex. removal

- Maximum trench width

(sheeting or trench box used)

Maximum

width at pipe

trench

0 3-2 10" 3'-2" 12" 3'-6" 18" 3'-10" 21" 4'-4" 24" 4'-8" 27" 4'-11" 30" 5'-3" 33" 6'-0"

Nominal

pipe dia (D)

6" min.

# SURVEY PROVIDED BY:

Plat of Survey and Topography Provided By TFW Surveying and Mapping Inc. For Eriksson Engineering Associates on July 3, 2015. Order Number 150518. Project Number 2029.

# PROJECT BENCHMARKS

1. Site Benchmark 1, Flange Bolt FH Elevation=686.60 2. Site Benchmark 1, Arrow Bolt FH Elevation=686.15

# J.U.L.I.E.

Note: The exact location of all utilities shall be verified by the contractor prior to construction activities. For utility locations call: J.U.L.I.E. 1 (800) 892—0123





# LEGEND **EXISTING** PROPOSED

——G—— ——ОН—— ——Е—— Telephone Line Fire Hydrant Buffalo Box

Utility Pole

Gas Valve ComEd Manhole

W 782.10 <sub>x</sub> 784.0 \_\_\_T/W\_785.20

Coniferous Tree

## Tree Protection Fencing at Drip Line

**GENERAL NOTES**  The Location of Existing Underground Utilities, Such As Watermains, Sewers, Gas Lines, Etc., As Shown On The Plans, Has Been Determined From The Best Available Information and Is Given For The Convenience of The Contractor. However, The Owner and The Engineer Do Not Assume Responsibility In The Event That During Construction, Utilities Other Than Those Shown May Be Encountered, and That The Actual Location of Those Which Are Shown May Be Different From The Location As Shown On The Drawings. Contact Engineer Immediately If Surface and/or Subsurface Features Are Different Than Shown On The Drawings.

- Notify The Engineer Without Delay of Any Discrepancies Between the Drawings and Existing Field Conditions.
- 3. Notify The Owner, Engineer and The A Minimum of 48 Hours In Advance of Performing Any Work.
- 4. All Areas, On or Off Site, Disturbed During Construction Operations and Not Part of the Work As Shown Hereon Shall Be Restored To Original Condition to the Satisfaction of the Owner at No Additional Cost to the Owner. It is Incumbent Upon Contractor to Show That Damaged Areas Were Not Disturbed By Construction Operations.
- 5. These Drawings Assume That The Contractor Will Utilize An Electronic Drawing File (DWG) and Stake All Site Improvements Accordingly.
- 6. No Person May Utilize The Information Contained Within These Drawings Without Written Approval From Eriksson Engineering Associates, Ltd.
- 7. The Engineer Is Furnishing These Drawings For Construction Purposes As A Convenience To The Owner, Architect, Surveyor, or Contractor. Prior To The Use Of These Drawings For Construction Purposes, The User Of This Media Shall Verify All Dimensions And Locations Of Buildings With The Foundation Drawings And Architectural Site Plan, and Coordinate All Dimensions and Locations of All Site Items. If Conflicts Exist The User Of This Information Shall Contact The Engineer Immediately.
- 8. Provide An As-built Survey Prepared By A Licensed Professional Land Surveyor In Accordance With The Authorities Having Jurisdiction Which May Include All Detention Basins, Including All Storm and Sanitary Sewers and Structure Locations, Sizes, Rim and Invert Elevations, Final Detention Volume Calculations For The Basin(s) and Watermain and Valve and Appurtenance Locations.
- The Illinois Department Of Transportation Standard Specifications For Road And Bridge Construction Latest Edition, And All Addenda Thereto, Shall Govern The Earthwork And Paving Work Under This Contract Unless Noted Otherwise.



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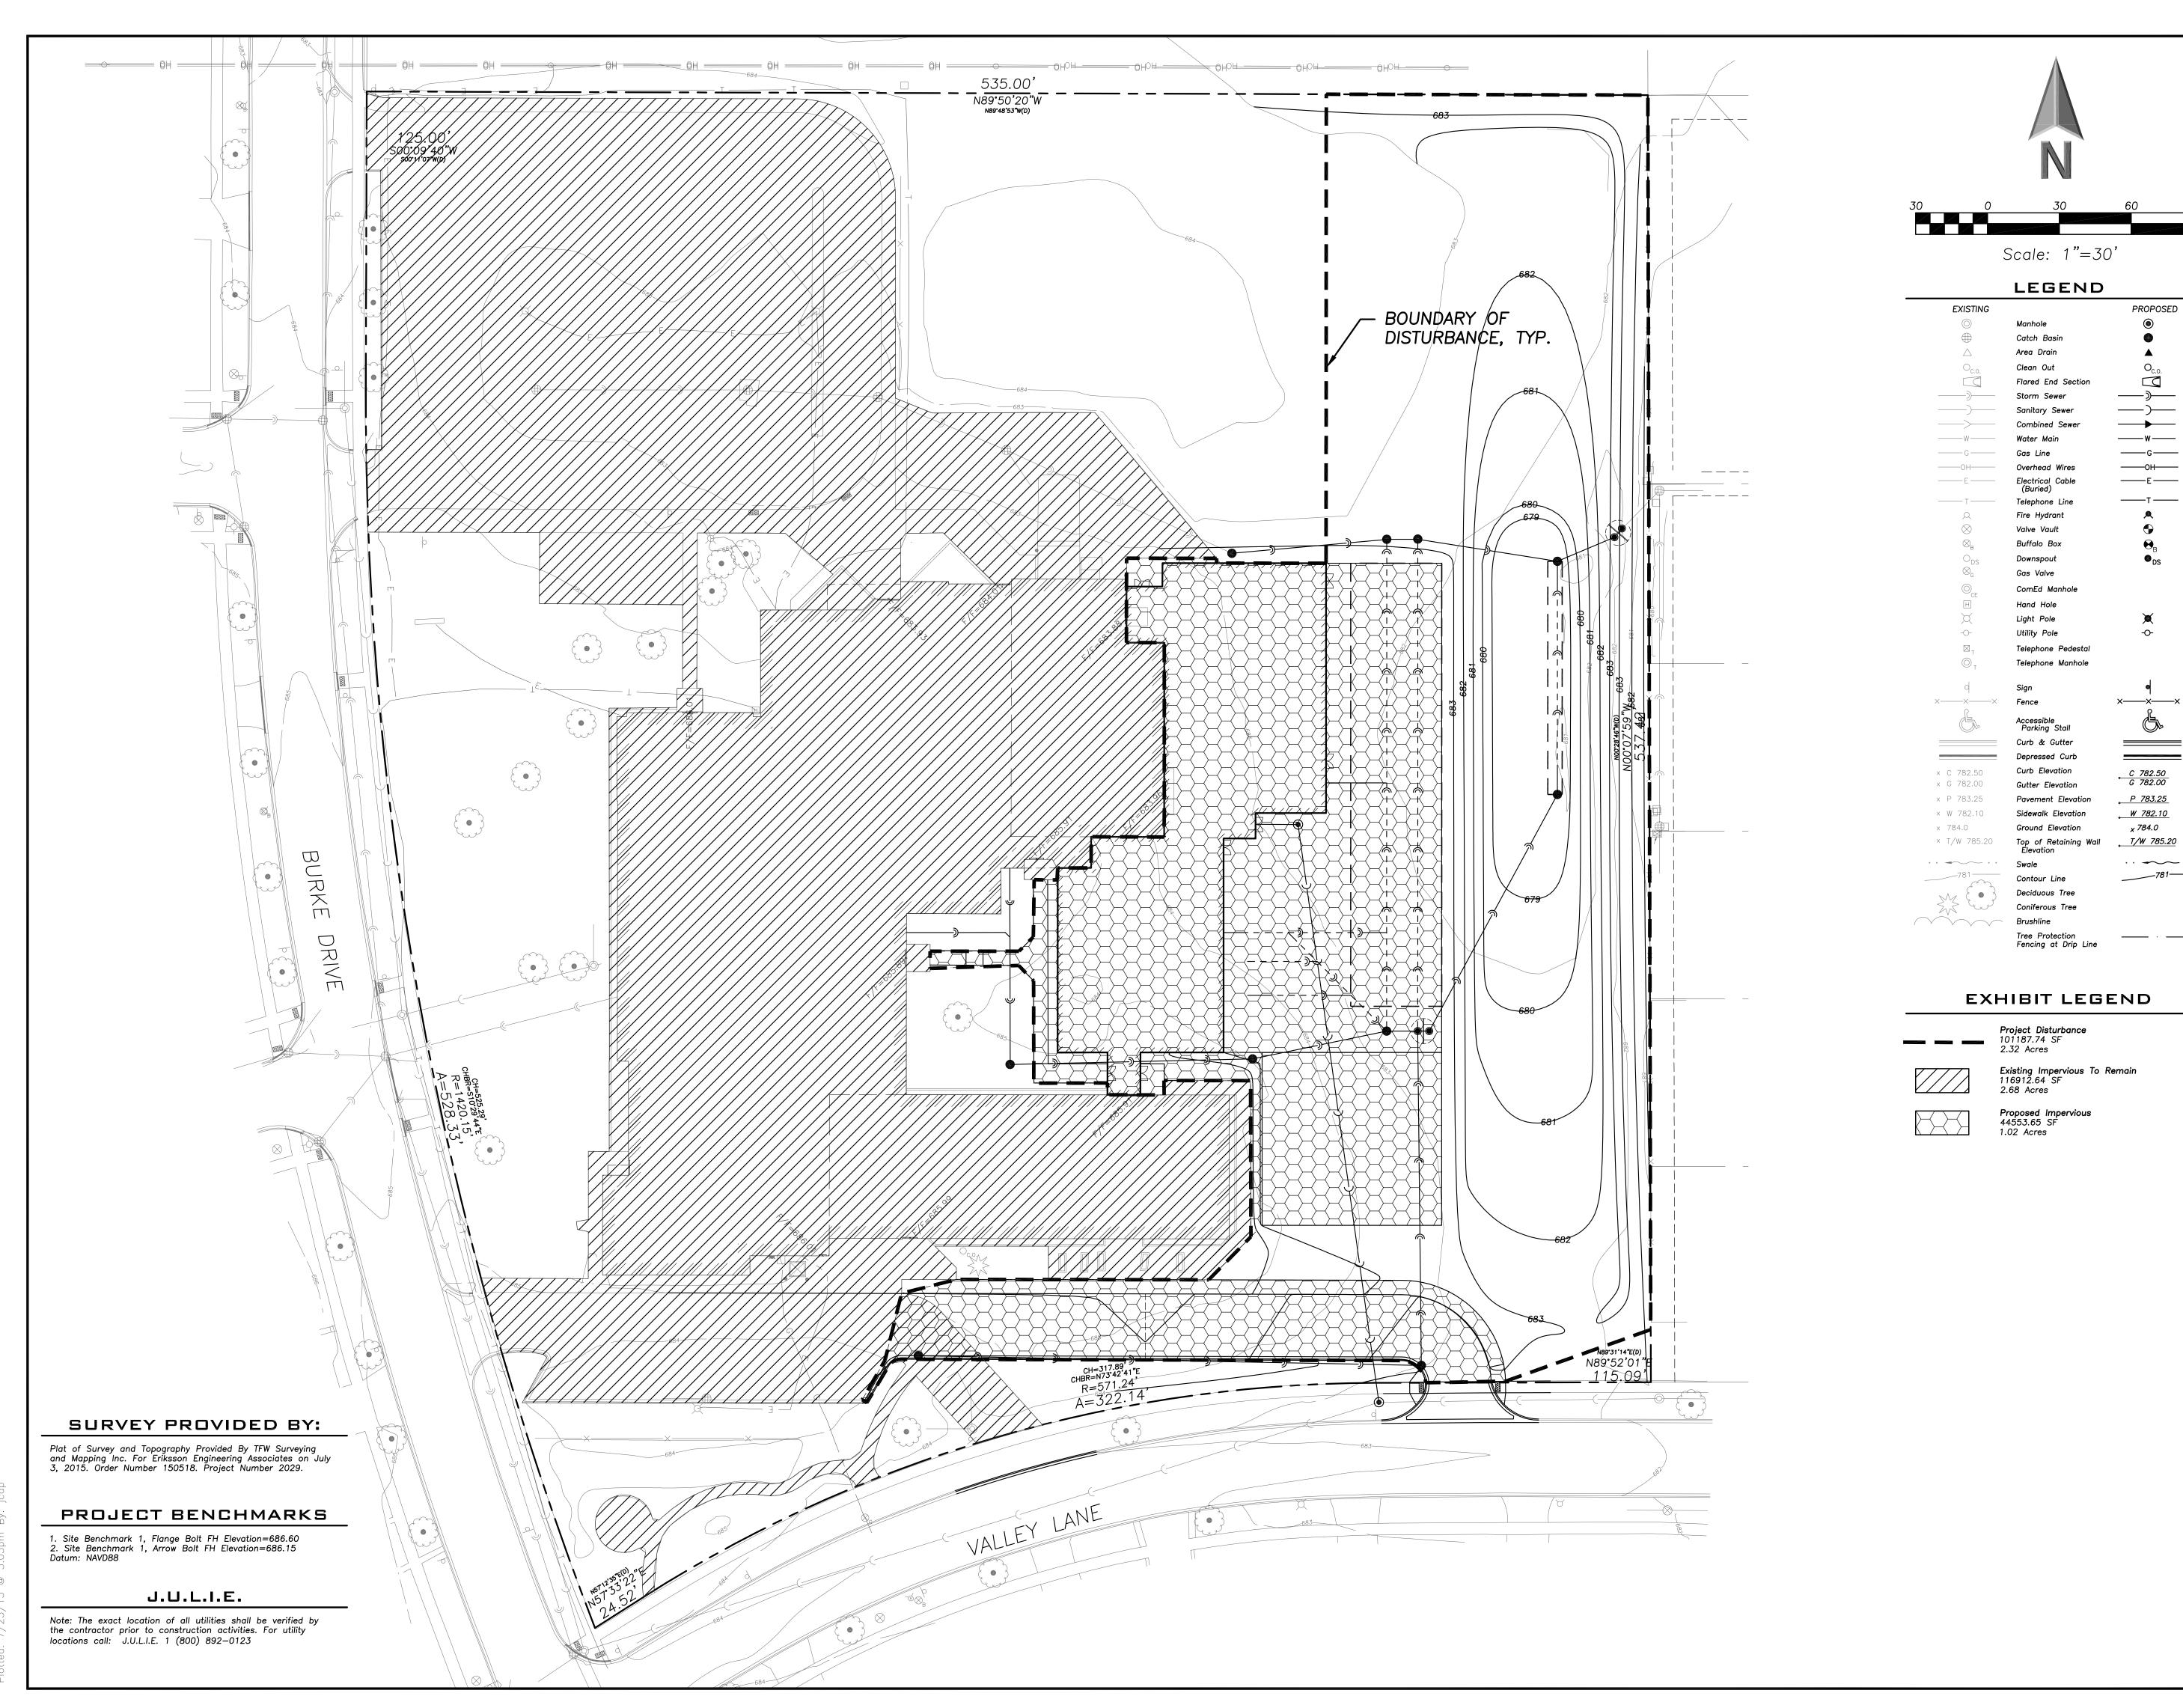
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Sheet Title:

**AUTOTURN EXHIBIT** 

CX-7.1





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ADDITION AND RENOVATION

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Design By:

JC

O6/06/15

Approved By:


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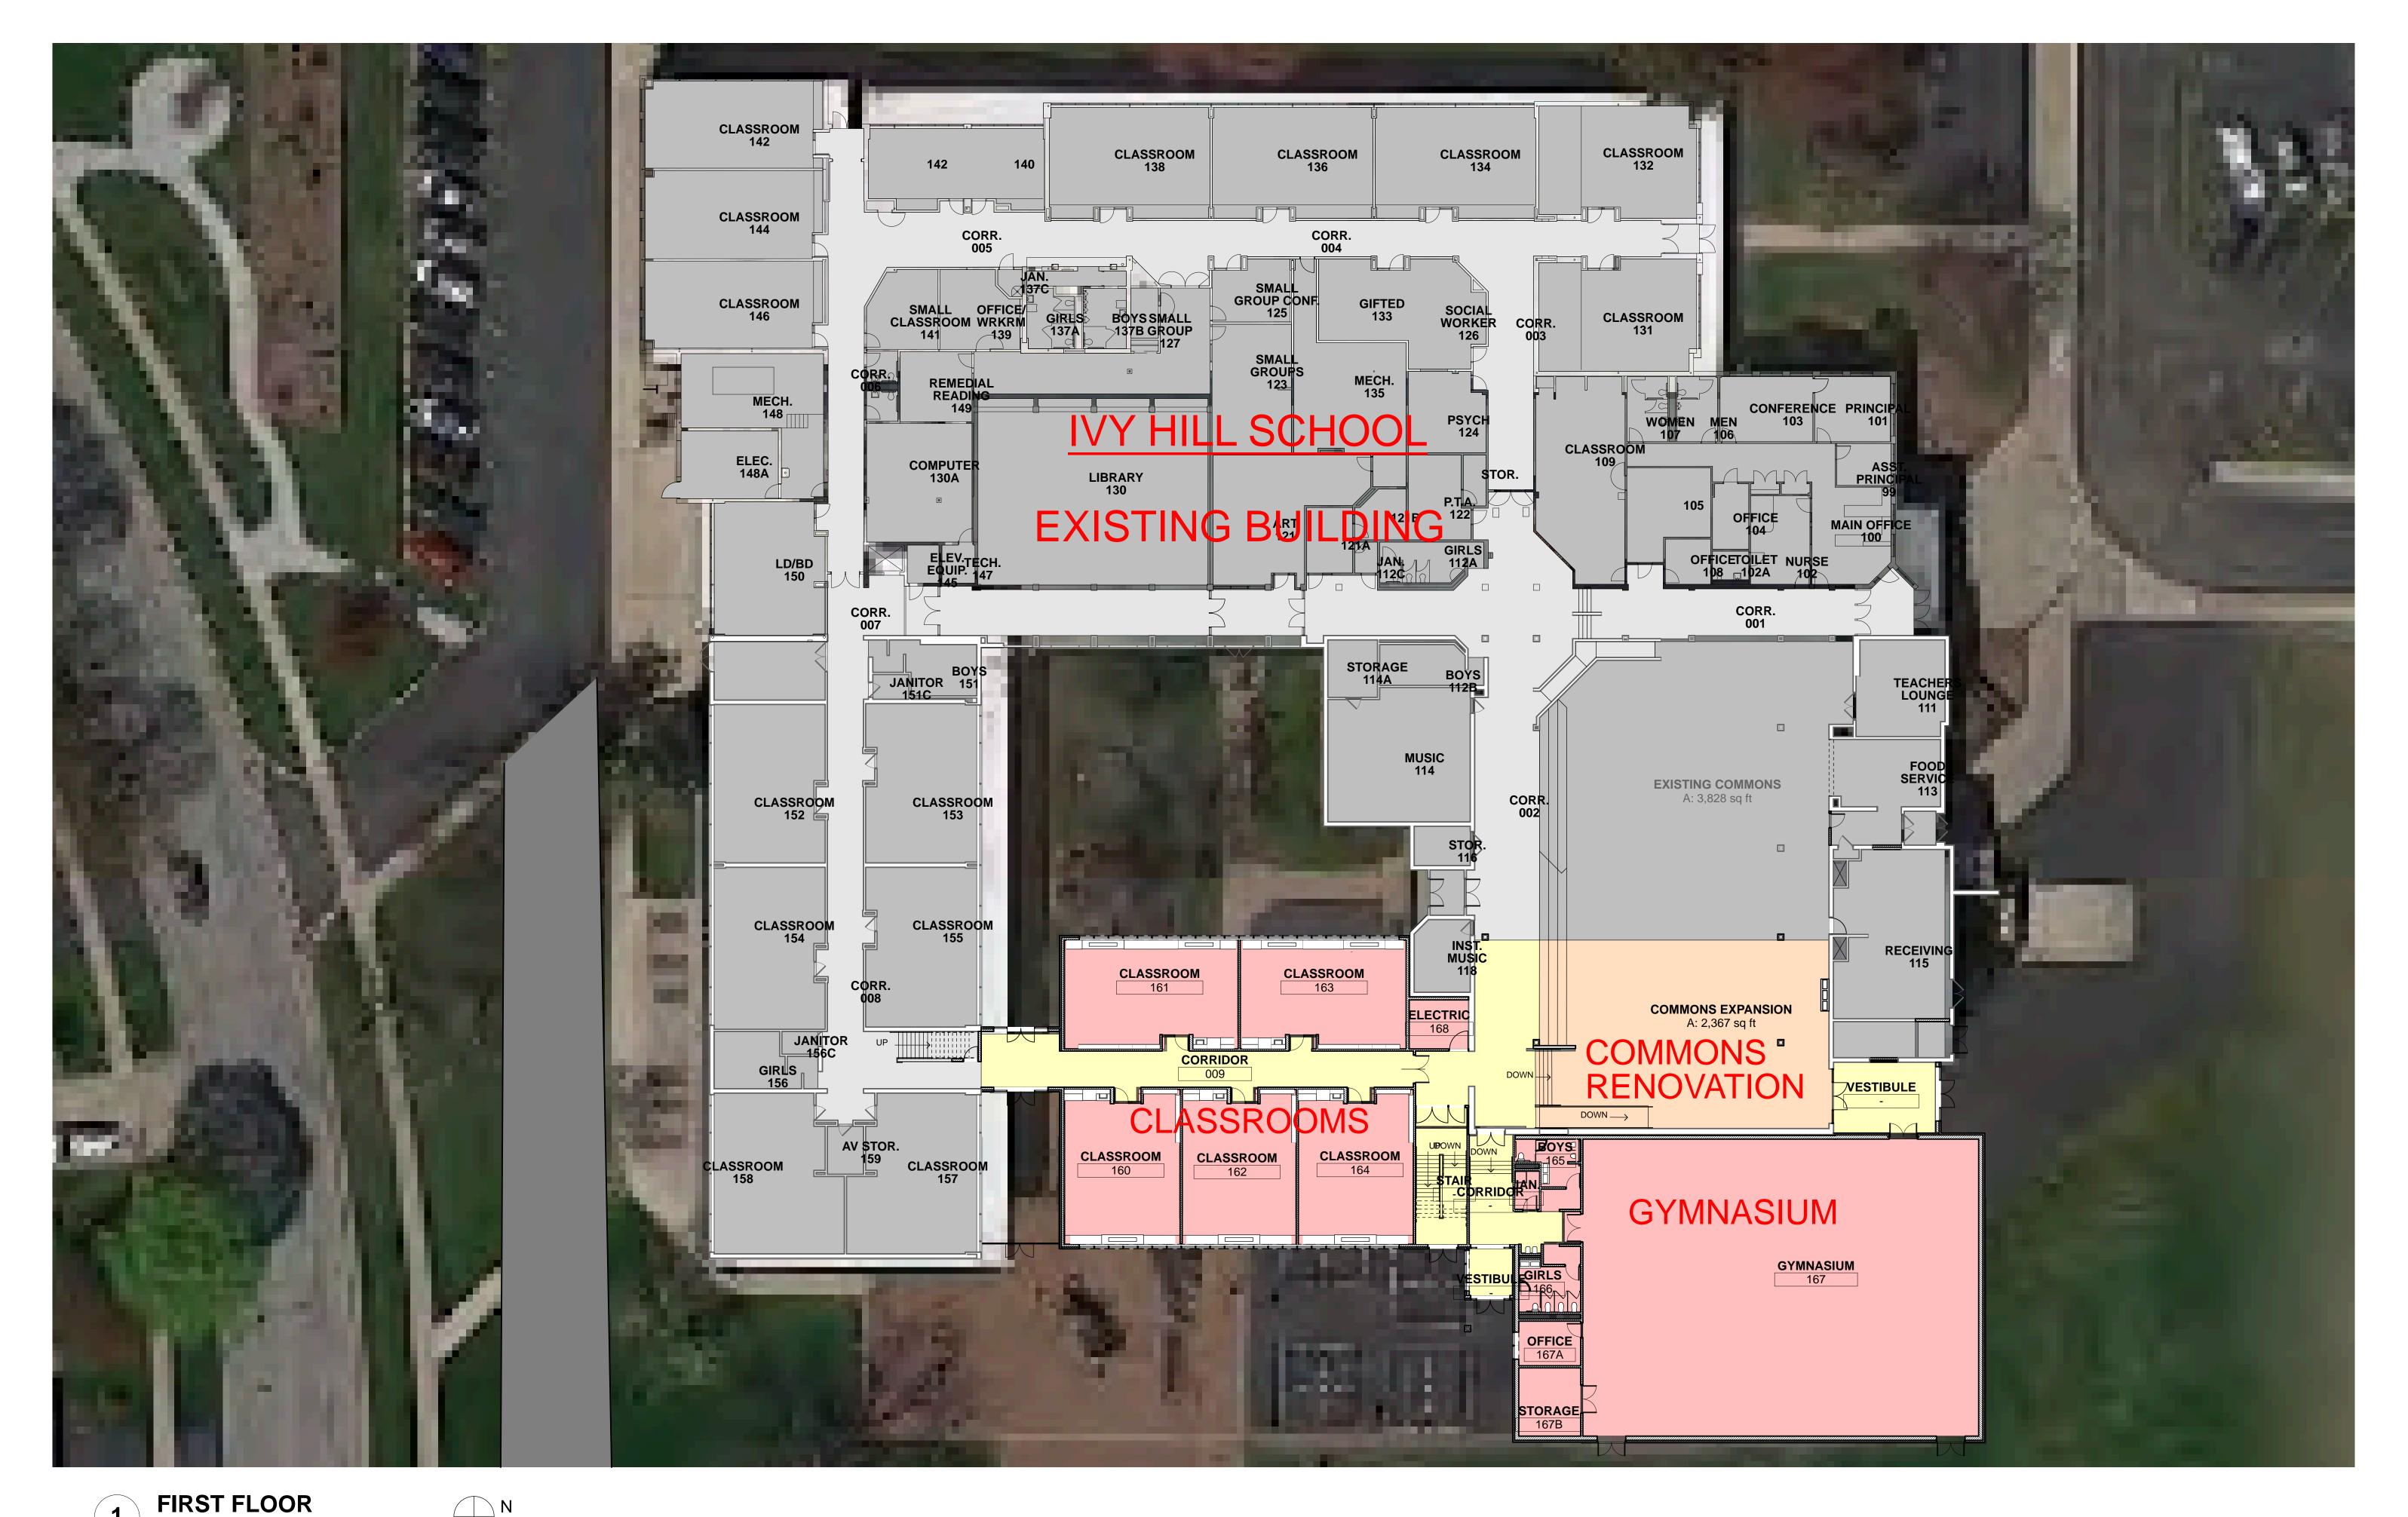
PROJECT DISTURBANCE

Sheet No

CX-7.2





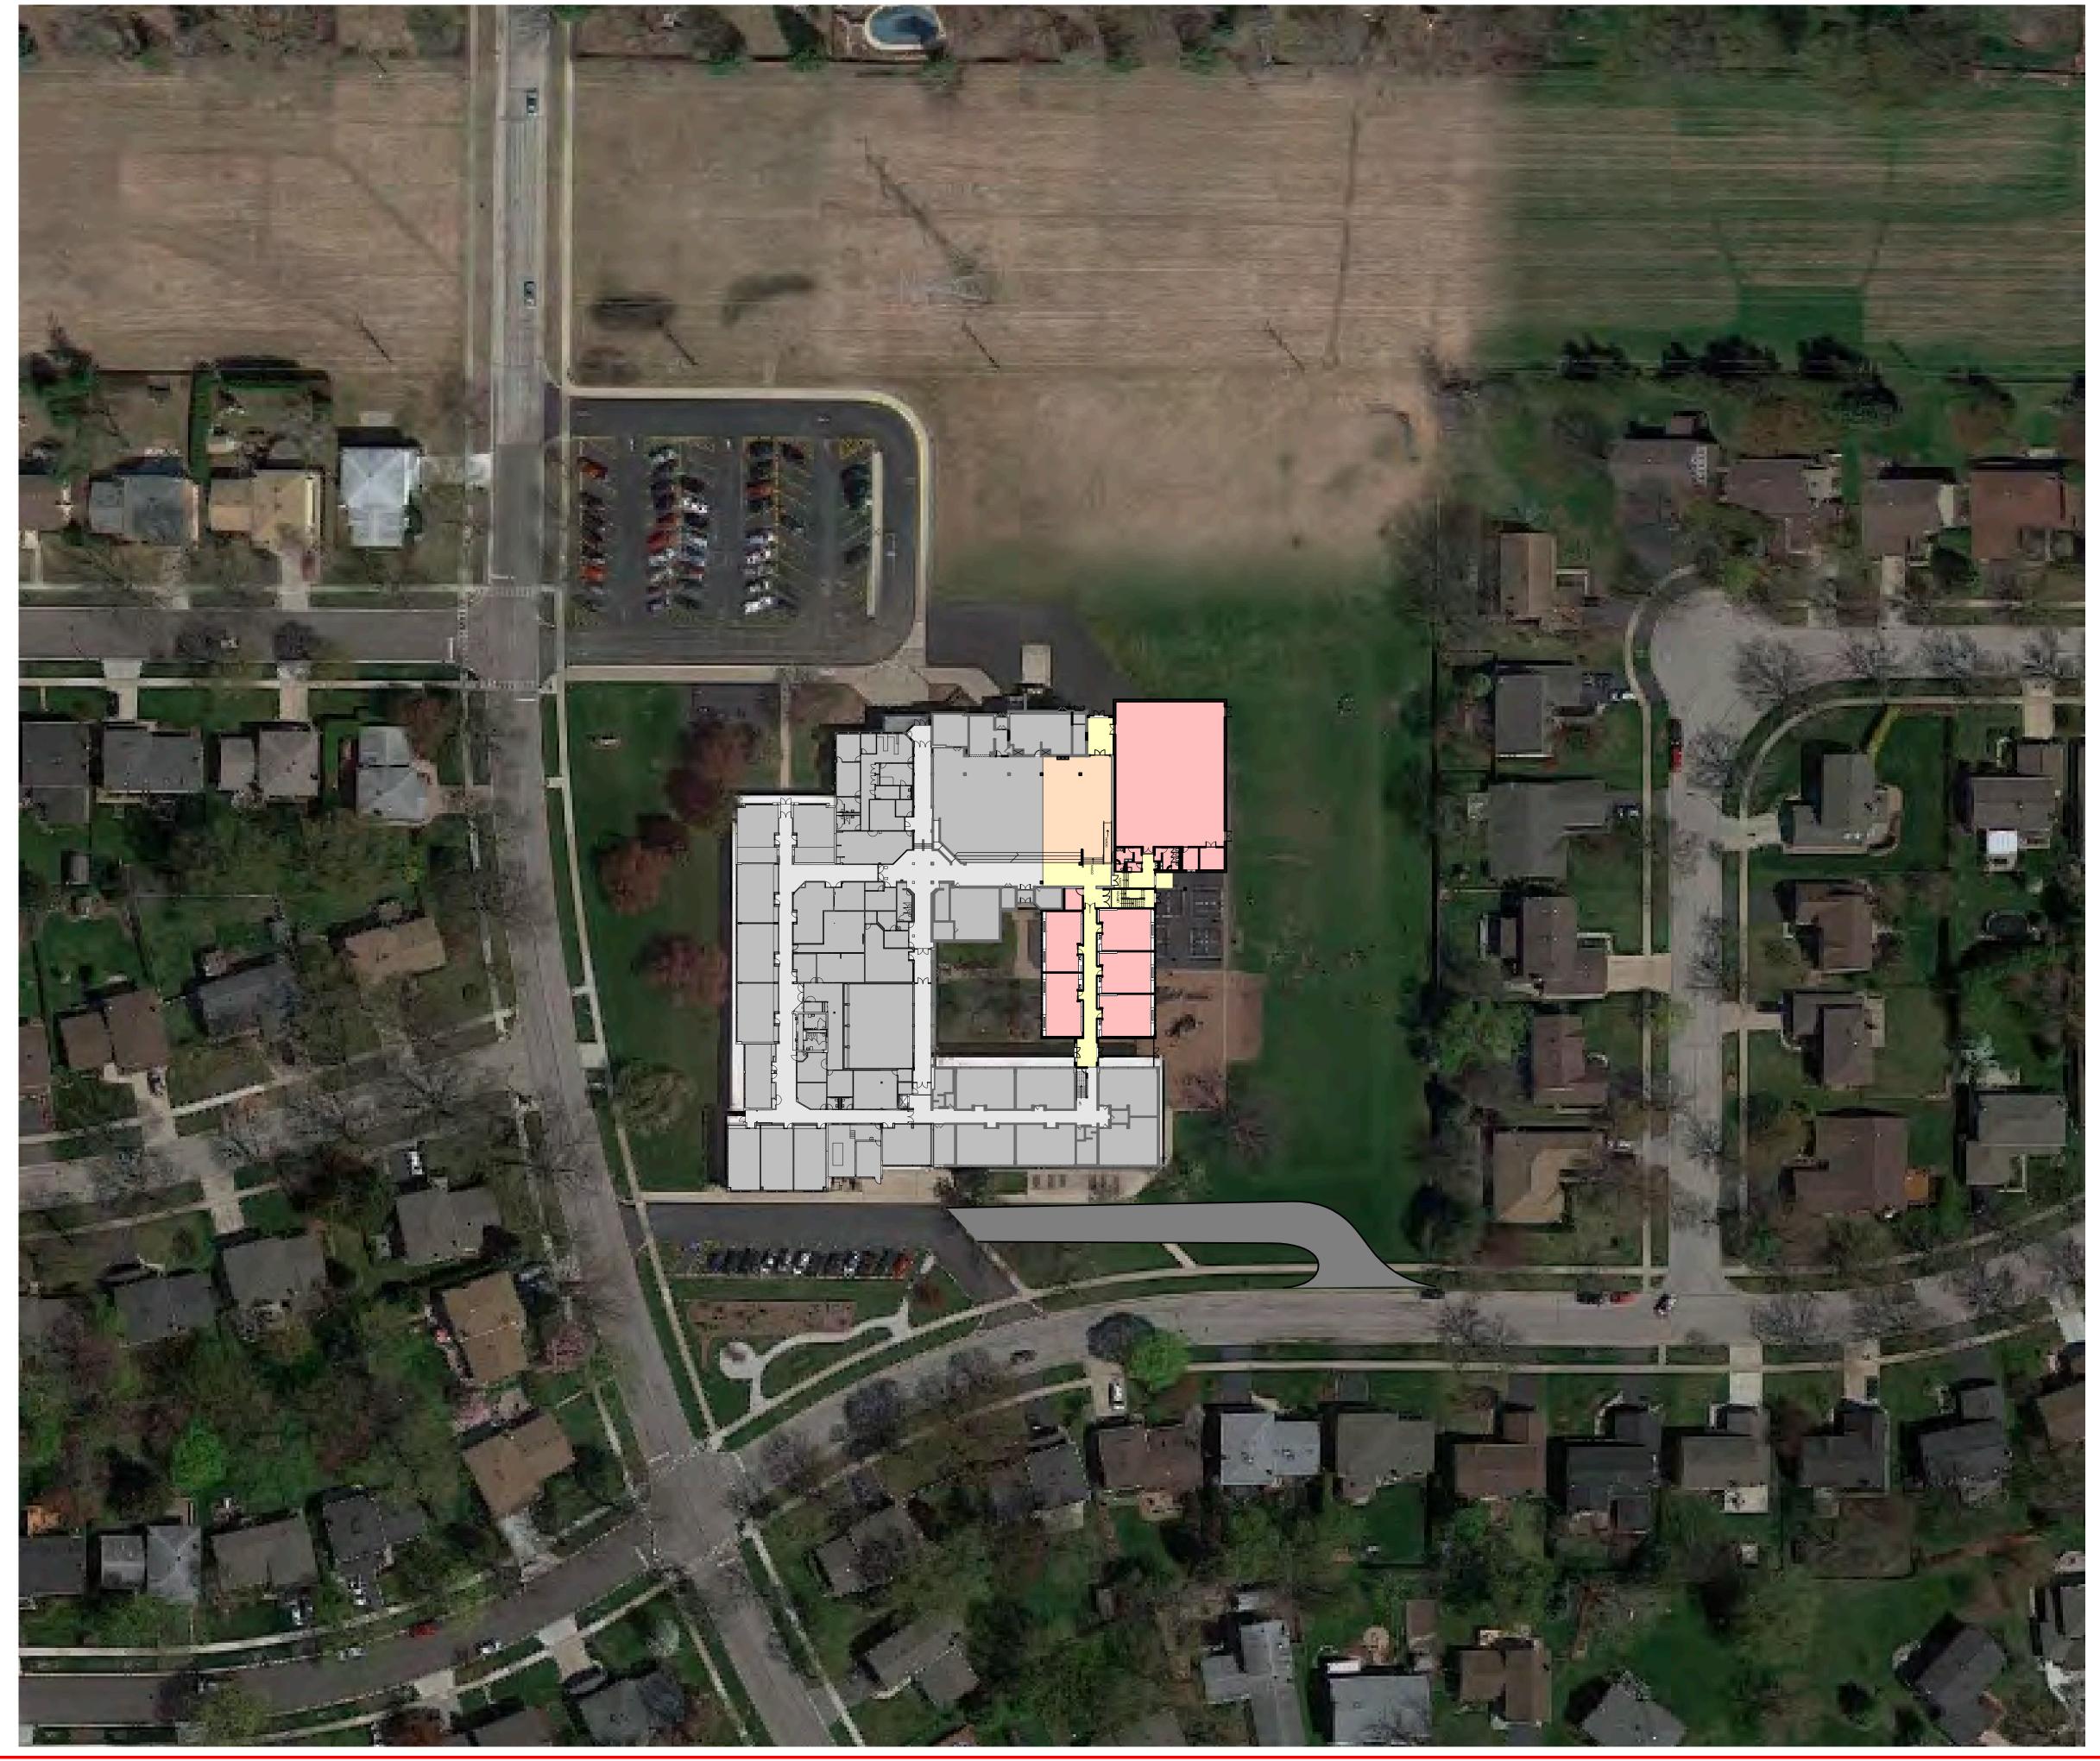




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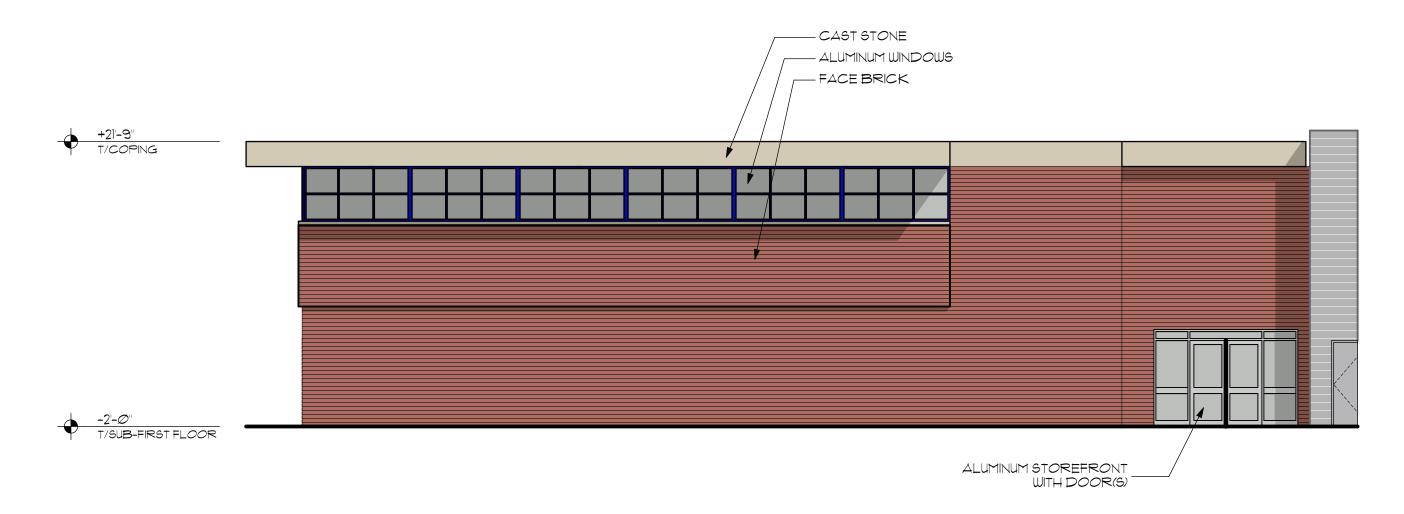






# 1 EXTERIOR ELEVATION - FACING EAST SCALE: 1/8" = 1'-0"




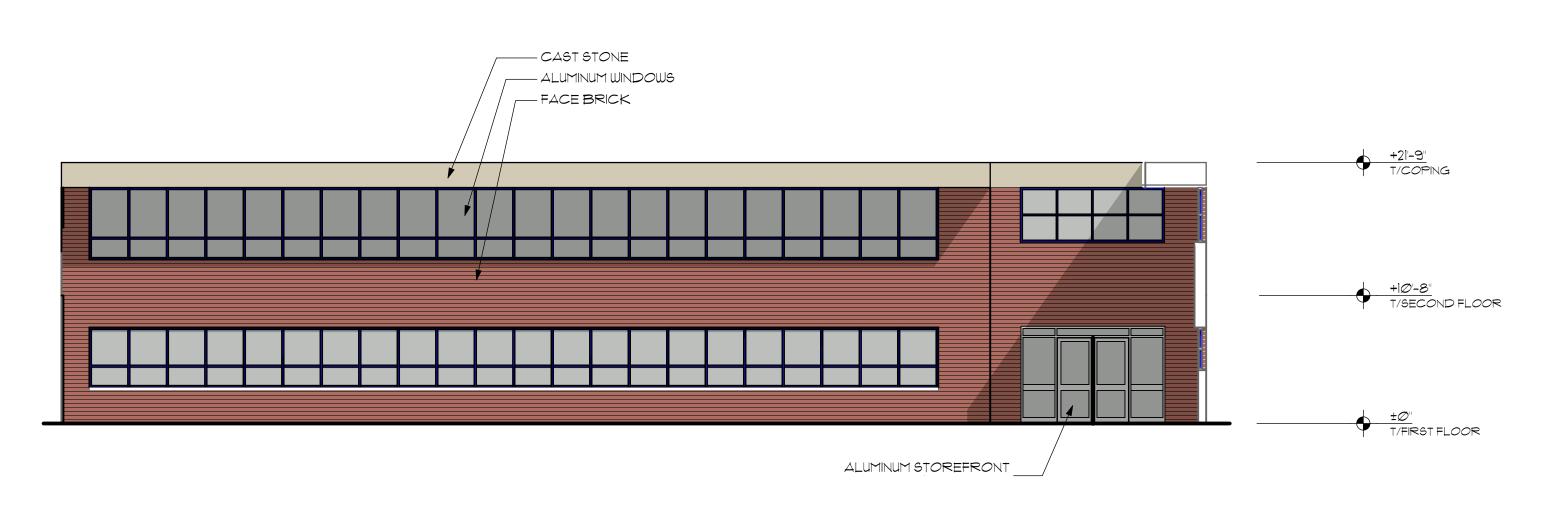

2 EXTERIOR ELEVATION - COURTYARD

SCALE: 1/8" = 1'-0"



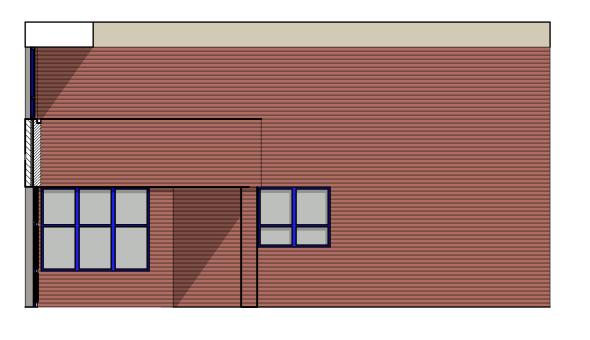








# **EXTERIOR ELEVATION - FACING EAST**

SCALE: 1/16" = 1'-0"

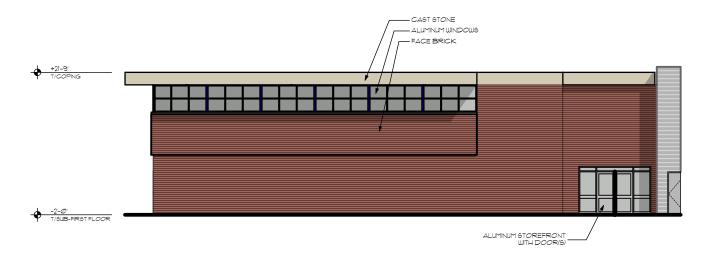

# **EXTERIOR ELEVATION - FACING NORTH**

SCALE: 1/16" = 1'-0"

# **EXTERIOR ELEVATIONS**

