


Olive Mary-Stitt School - Existing 599 Students

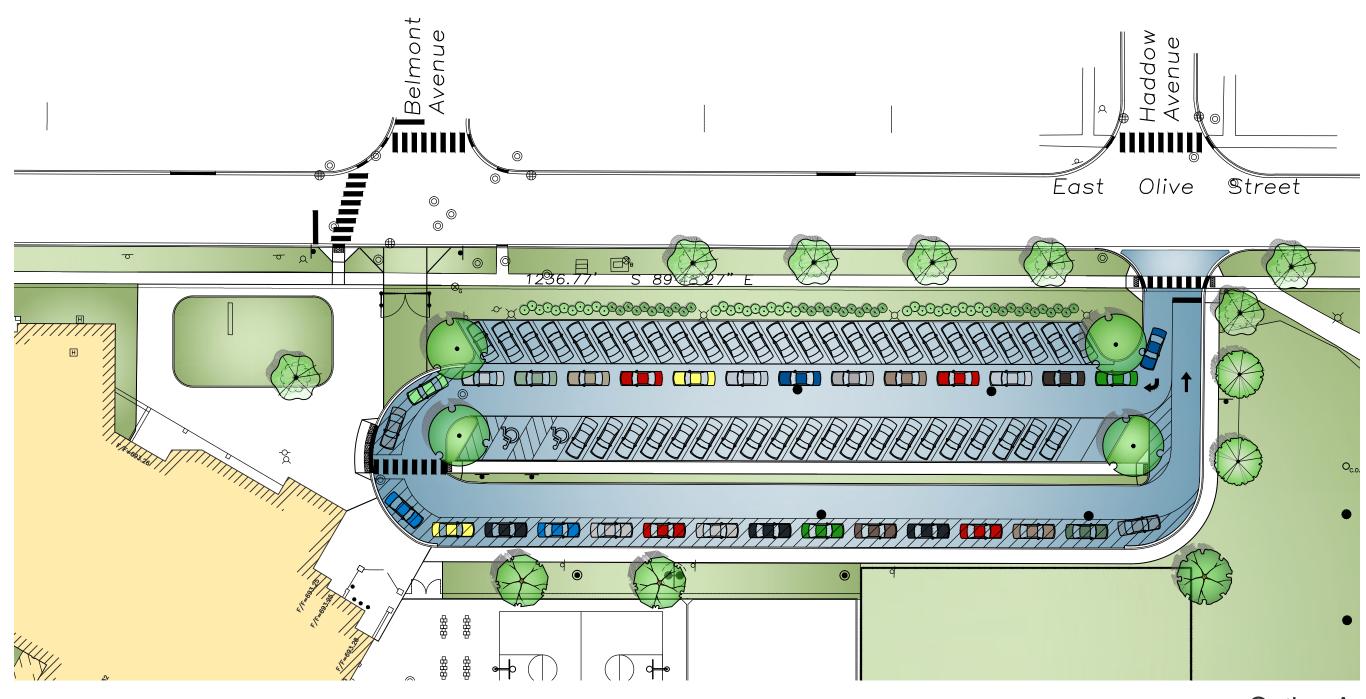


Olive Mary-Stitt School - Proposed 642 Students

Option A Proposed Stacking for 31 Cars

7% Student increase over existing

55% Increase of onsite car stacking

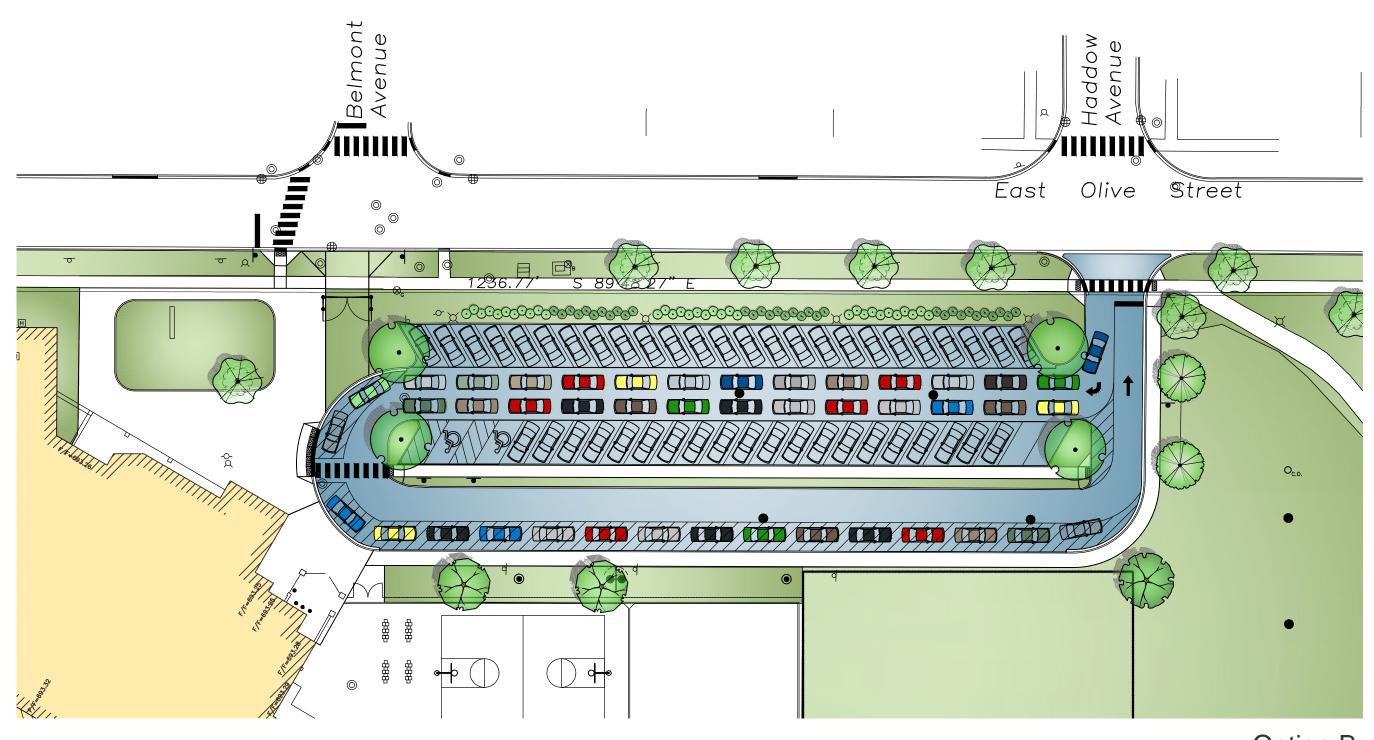


Olive Mary-Stitt School - Proposed 642 Students

Option B Proposed Stacking for 44 Cars

7% Student increase over existing

120% Increase of onsite car stacking

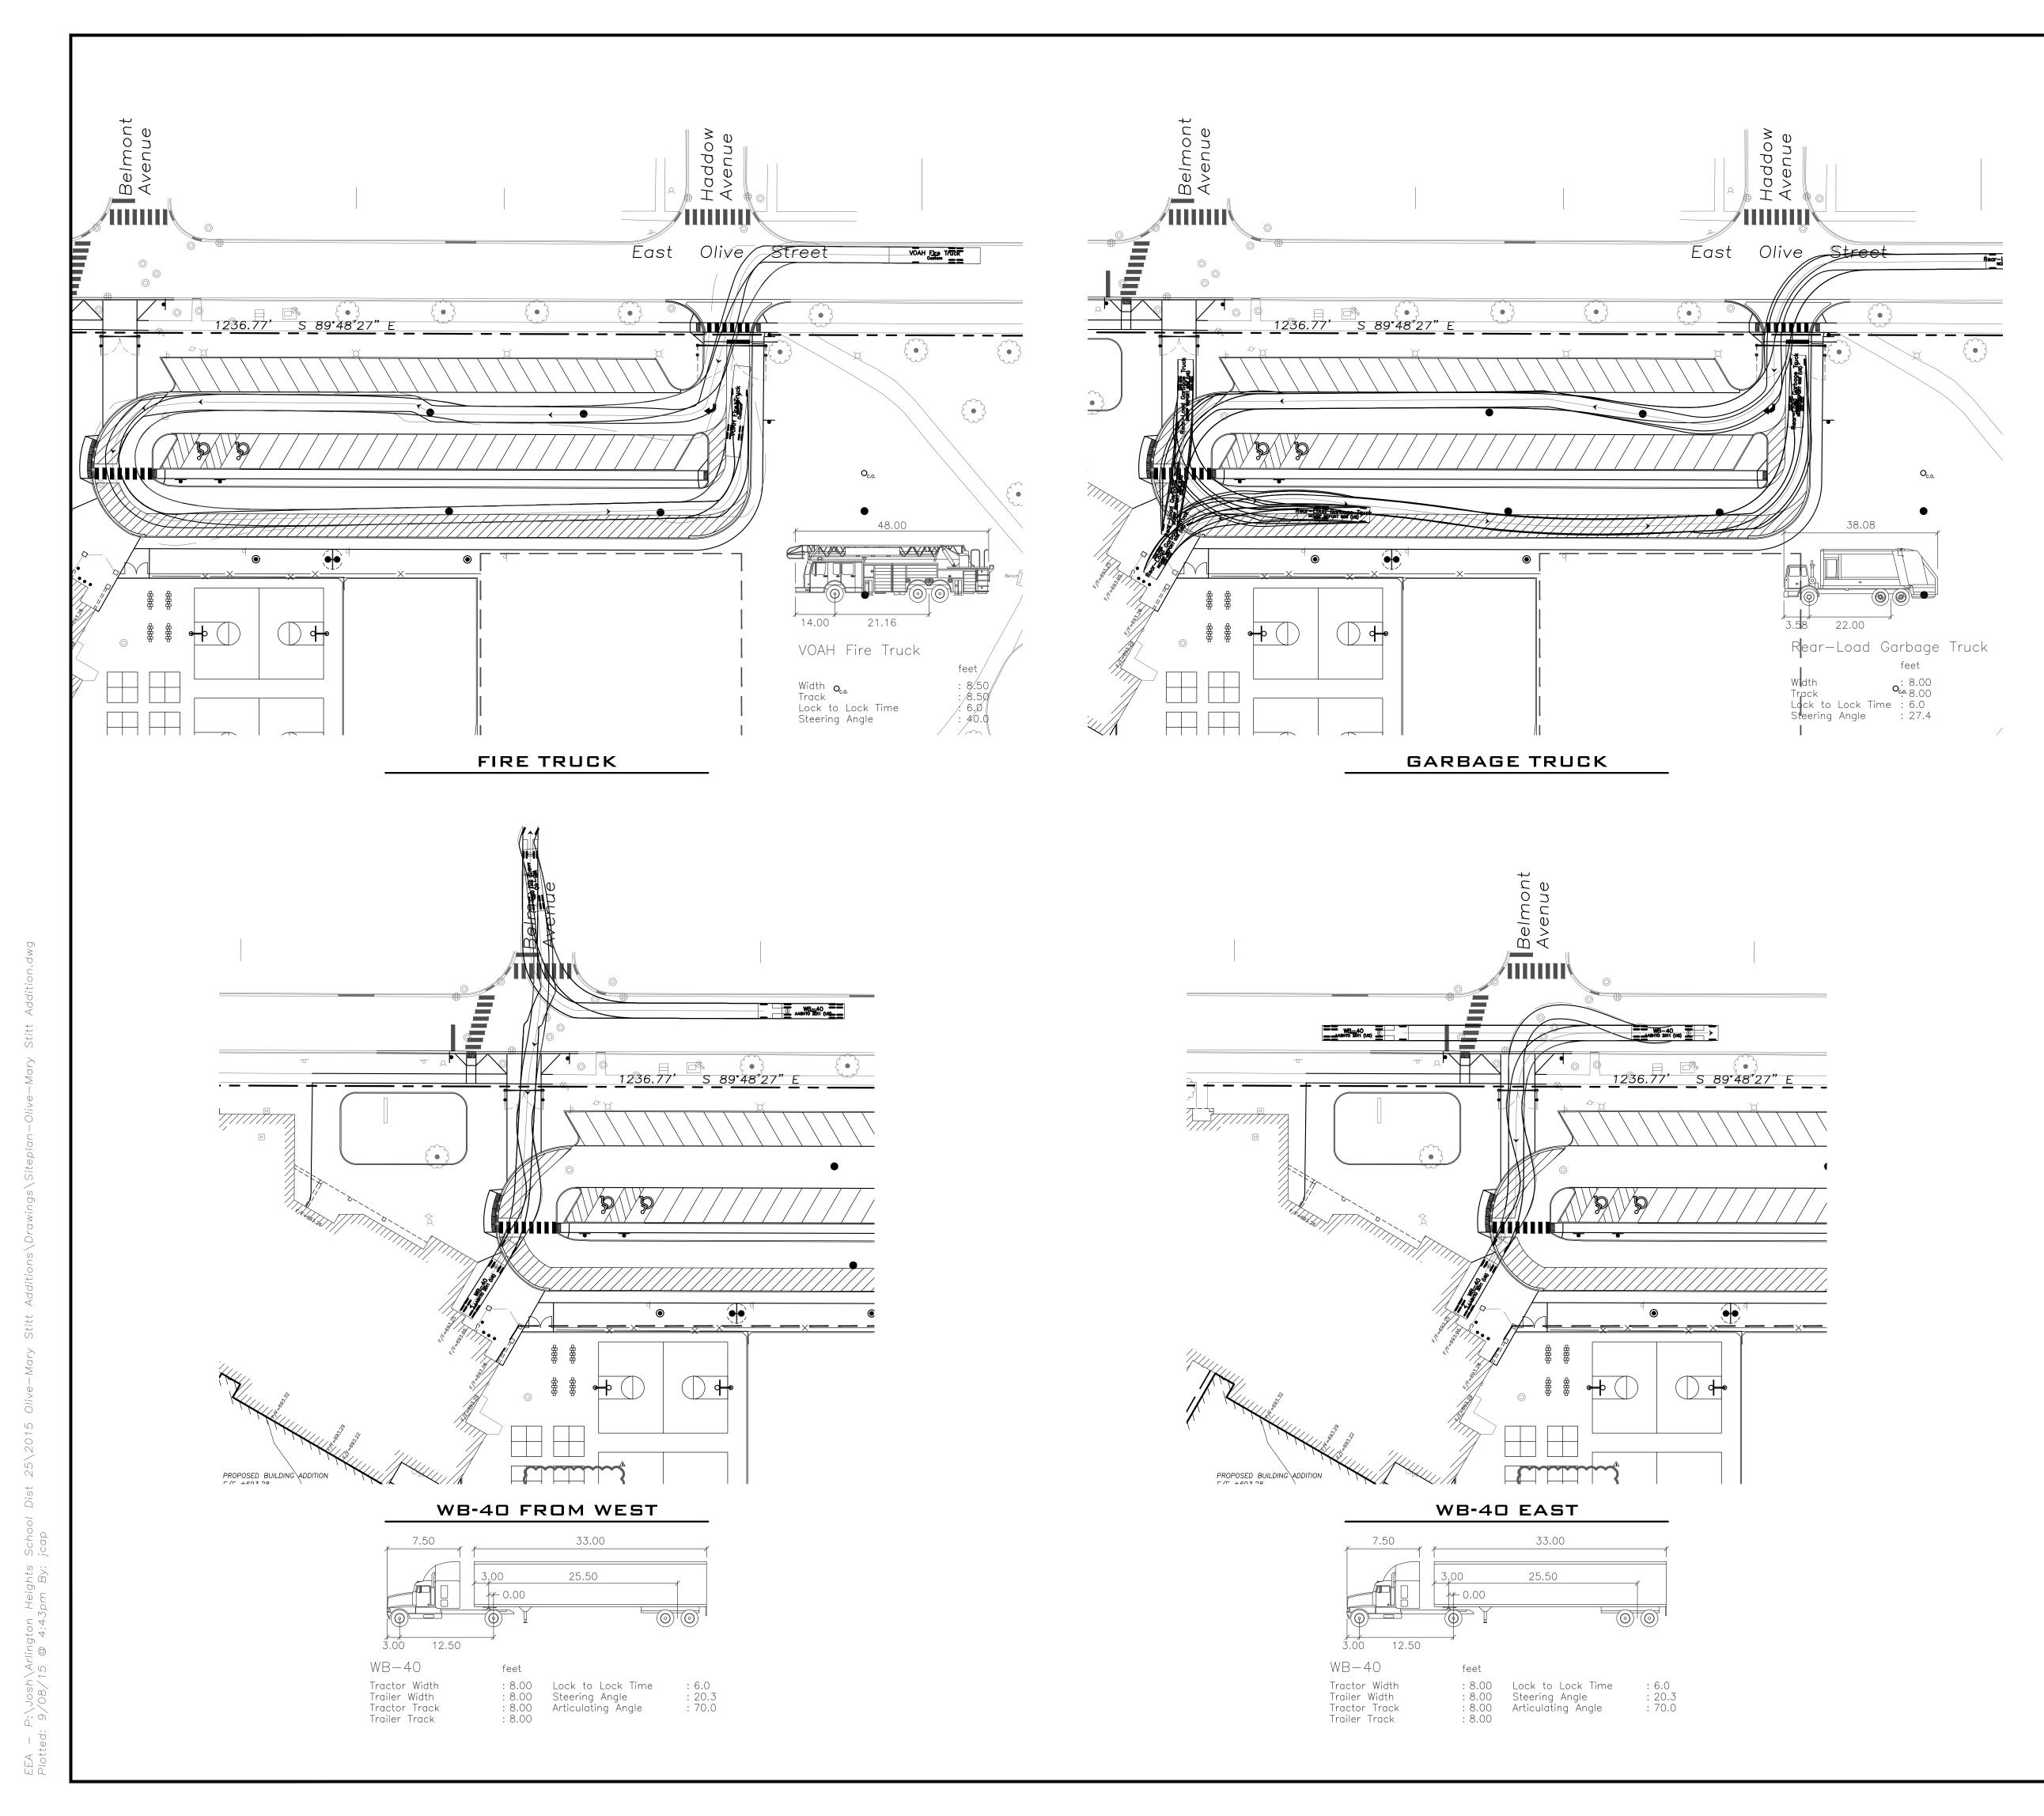





Scale: 1"=40'

LEGEND

EXISTING		PROPOSED
(i)	Manhole	•
#	Catch Basin	•
O _{c.o.}	Clean Out	O _{c.o.}
C.O.	Flared End Section	<u> </u>
	Storm Sewer	
	Sanitary Sewer	<u></u>
<u> </u>	Combined Sewer	-
W	Water Main	
G	Gas Line	
OH	Overhead Wires	
——Е——	Electrical Cable (Buried)	——Е——
—— Т	Telephone Line	
Q	Fire Hydrant	
\otimes	Valve Vault	
\bigotimes_{B}	Buffalo Box	
O_DS	Downspout	
$\bigotimes_{\mathbb{G}}$	Gas Valve	
Н	Hand Hole	
<u> </u>	Light Pole	
-0-	Utility Pole	
d	Sign	•
××	Fence	××
	Accessible Parking Stall	Ġ.
	Curb & Gutter	
	Depressed Curb	
× C 782.50	Curb Elevation	C 782.50
x G 782.00	Gutter Elevation	G 782.00
x P 783.25	Pavement Elevation	P 783.25
× W 782.10	Sidewalk Elevation	W 782.10
x 784.0	Ground Elevation	_x 784.0
× T/W 785.20	Top of Retaining Wall Elevation	T/W 785.20
. ••••••	Swale	•••••••••••••••••••••••••••••••••••••••
	Contour Line	781
₩ E•3	Deciduous Tree	
	Coniferous Tree	
	Brushline	
	Tree Protection Fencing at Drip Line	·

GENERAL NOTES

- 1. The Location of Existing Underground Utilities, Such As Watermains, Sewers, Gas Lines, Etc., As Shown On The Plans, Has Been Determined From The Best Available Information and Is Given For The Convenience of The Contractor. However, The Owner and The Engineer Do Not Assume Responsibility In The Event That During Construction, Utilities Other Than Those Shown May Be Encountered, and That The Actual Location of Those Which Are Shown May Be Different From The Location As Shown On The Drawings. Contact Engineer Immediately If Surface and/or Subsurface Features Are Different Than Shown On The Drawings.
- Notify The Engineer Without Delay of Any Discrepancies Between the Drawings and Existing Field Conditions.
- Notify The Owner, Engineer and The A Minimum of 48 Hours In Advance of Performing Any Work.
- 4. All Areas, On or Off Site, Disturbed During Construction Operations and Not Part of the Work As Shown Hereon Shall Be Restored To Original Condition to the Satisfaction of the Owner at No Additional Cost to the Owner. It is Incumbent Upon Contractor to Show That Damaged Areas Were Not Disturbed By Construction Operations.
- These Drawings Assume That The Contractor Will Utilize An Electronic Drawing File (DWG) and Stake All Site Improvements Accordingly.
- No Person May Utilize The Information Contained Within These Drawings Without Written Approval From Eriksson Engineering Associates, Ltd.
- 7. The Engineer Is Furnishing These Drawings For Construction Purposes As A Convenience To The Owner, Architect, Surveyor, or Contractor. Prior To The Use Of These Drawings For Construction Purposes, The User Of This Media Shall Verify All Dimensions And Locations Of Buildings With The Foundation Drawings And Architectural Site Plan, and Coordinate All Dimensions and Locations of All Site Items. If Conflicts Exist The User Of This Information Shall Contact The Engineer Immediately.
- 8. Provide An As—built Survey Prepared By A Licensed Professional Land Surveyor In Accordance With The Authorities Having Jurisdiction Which May Include All Detention Basins, Including All Storm and Sanitary Sewers and Structure Locations, Sizes, Rim and Invert Elevations, Final Detention Volume Calculations For The Basin(s) and Watermain and Valve and Appurtenance Locations.
- The Illinois Department Of Transportation Standard Specifications For Road And Bridge Construction Latest Edition, And All Addenda Thereto, Shall Govern The Earthwork And Paving Work Under This Contract Unless Noted Otherwise.



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DLIVE-MARY STITT SCHOOL DDITION AND RENOVATION

Reserved for Seal:

Expiration Date:__

No.	Date	Description	
2	07/23/15	ISSUED FOR REVIEW	
3	08/05/15	ISSUED FOR REVIEW	
4	08/31/15	ISSUED FOR BID & PERMIT	
1	09/08/15	ADDENDUM #1	
	09/08/15	ISSUED FOR PERMIT	

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Design By:

JC

Date:

06/06/15

Approved By:

KC

Sheet Title:

AUTOTURN EXHIBIT

Sheet No:

CX8.1